## VISSER BROTHERS, INC **IRONWOOD MANUFACTURING** 13960 IRONWOOD DR. NW, TALLMADGE TOWNSHIP MI 49544 **ISSUED FOR: SITE PLAN REVIEW** DATE: JUNE 9th, 2022

## LEGAL DESCRIPTION

4 LL TH N TO BEG. ALSO W 660 FT OF NE 1/4 LYING S OF I-96 & NE'LY OF IRONWOOD DR SEC 1 T7N R13'

#### CONTACT INFORMATION

APPLICANT:

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DEG DEVELOPMENT CO 1946 TURNER AVE NW GRAND RAPIDS. MI 49504 PATRICK FATE VISSER BROTHERS 1946 TURNER AVE NW

PLANS PREPARED BY:


PROGRESSIVE AE 1811 4 MILE ROAD NE GRAND RAPIDS, MI 49525

GRAND RAPIDS, MI 49504

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This item has been electronically signed and sealed by Laura Renee Schaner using a Digital Signature and date. Printed copies of this document are not considered signed and sealed and the signature must be verified on any electronic copies.



NORTH

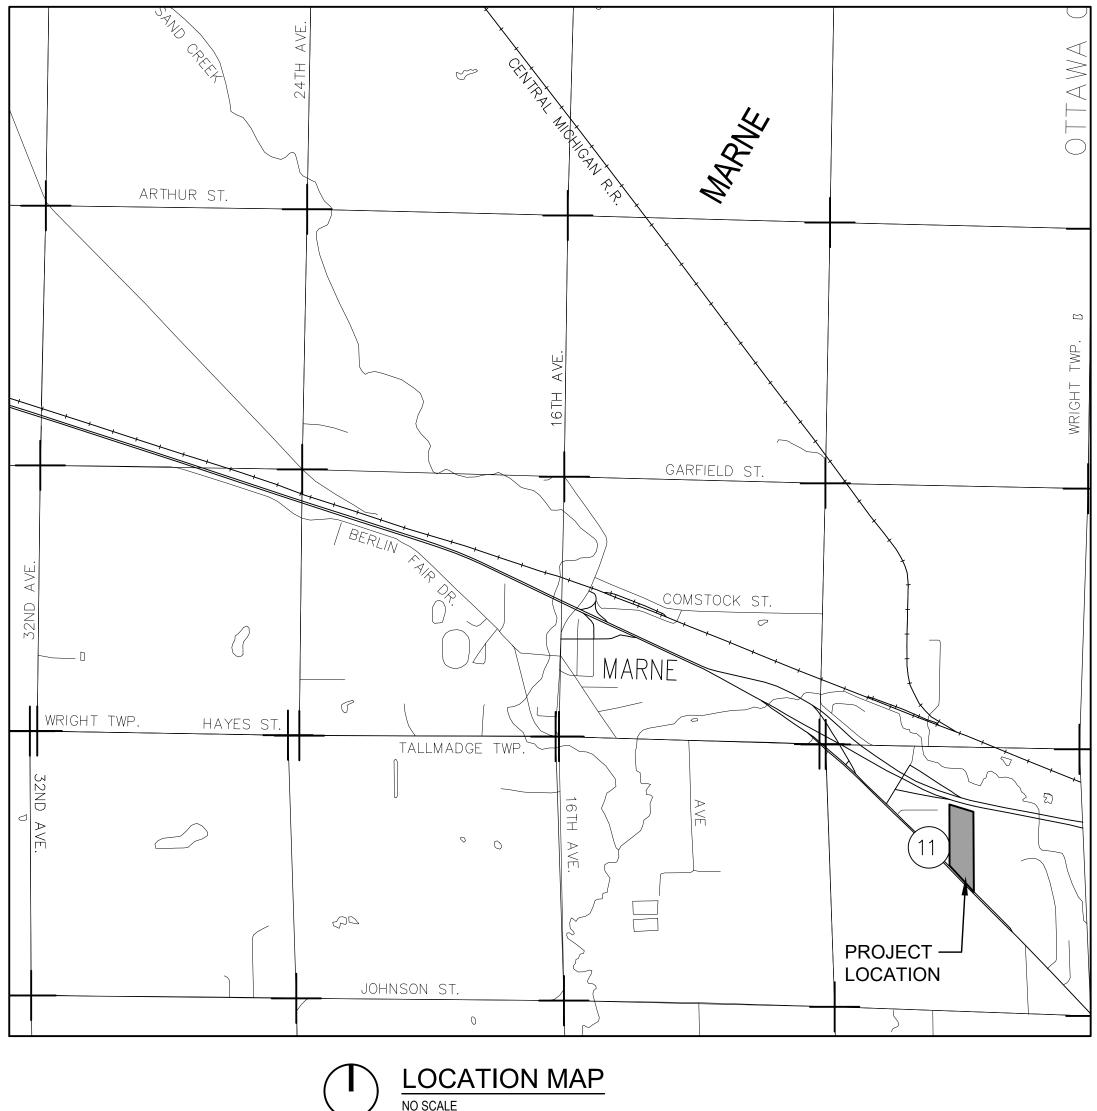**CONTACTS & AGENCIES** 

KENT COUNTY ROAD COMMISSION 1500 SCRIBNER AVE. NW GRAND RAPIDS, MI 49504 (616) 336-2500

M.D.O.T. 1420 FRONT AVE. NW GRAND RAPIDS, MI 49504 (616) 451-3091

GAINES TOWNSHIP 8555 KALAMAZOO AVE SE CALEDONIA TOWNSHIP, MI 49316 (616) 698-7980

CONSUMERS ENERGY (ELECTRIC) 4000 CLAY AVE. GRAND RAPIDS, MI 49540 (616) 530-4347

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CALL 811 NOTE:

CONTRACTOR TO CONTACT 811 SERVICE AT LEAST 3 WORKING DAYS PRIOR TO CONSTRUCTION, TO CONFIRM LOCATION OF EXISTING UTILITIES. DIAL 811.

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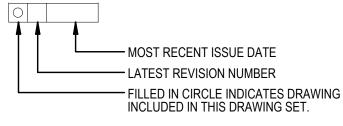
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## DRAWING INDEX

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• - 06/09/22	ES001	SITE PHOTOMETRIC

#### DRAWING LIST LEGEND



AT&T (TELEPHONE) ROOM 5 (PROJECTS N. OF FRANKLIN ST.) 2ND FLOOR (PROJECTS S. OF FRANKLIN ST.) 955 36TH ST. SE GRAND RAPIDS, MI 49508 (616) 246-7320

DTE ENERGY (NATURAL GAS) 4420 44TH ST., SUITE B GRAND RAPIDS, MI 49512 (616) 954-4575

XFINITY/COMCAST (CABLE TV) 955 CENTURY AVE. SW GRAND RAPIDS. MI 49503 (616) 977-2200 EXT: 3436

VERIZON BUSINESS (FIBER OPTICS) 2855 OAK INDUSTRIAL DR. NE GRAND RAPIDS, MI 49505 (616) 224-4944

CENTURY TEL (FIBER OPTICS) 212 CYPRESS ST. WEST MONROE, LA 71291 (616) 776-3617

CHOICEONE (FIBER OPTICS) 44 GRANDVILLE AVE. SW, STE. 400 GRAND RAPIDS, MI 49503 (616) 988-7100

US SIGNAL COMPANY, LLC (FIBER OPTICS) 20 MONROE AVE. NW GRAND RAPIDS, MI 49503 (616) 988-7031

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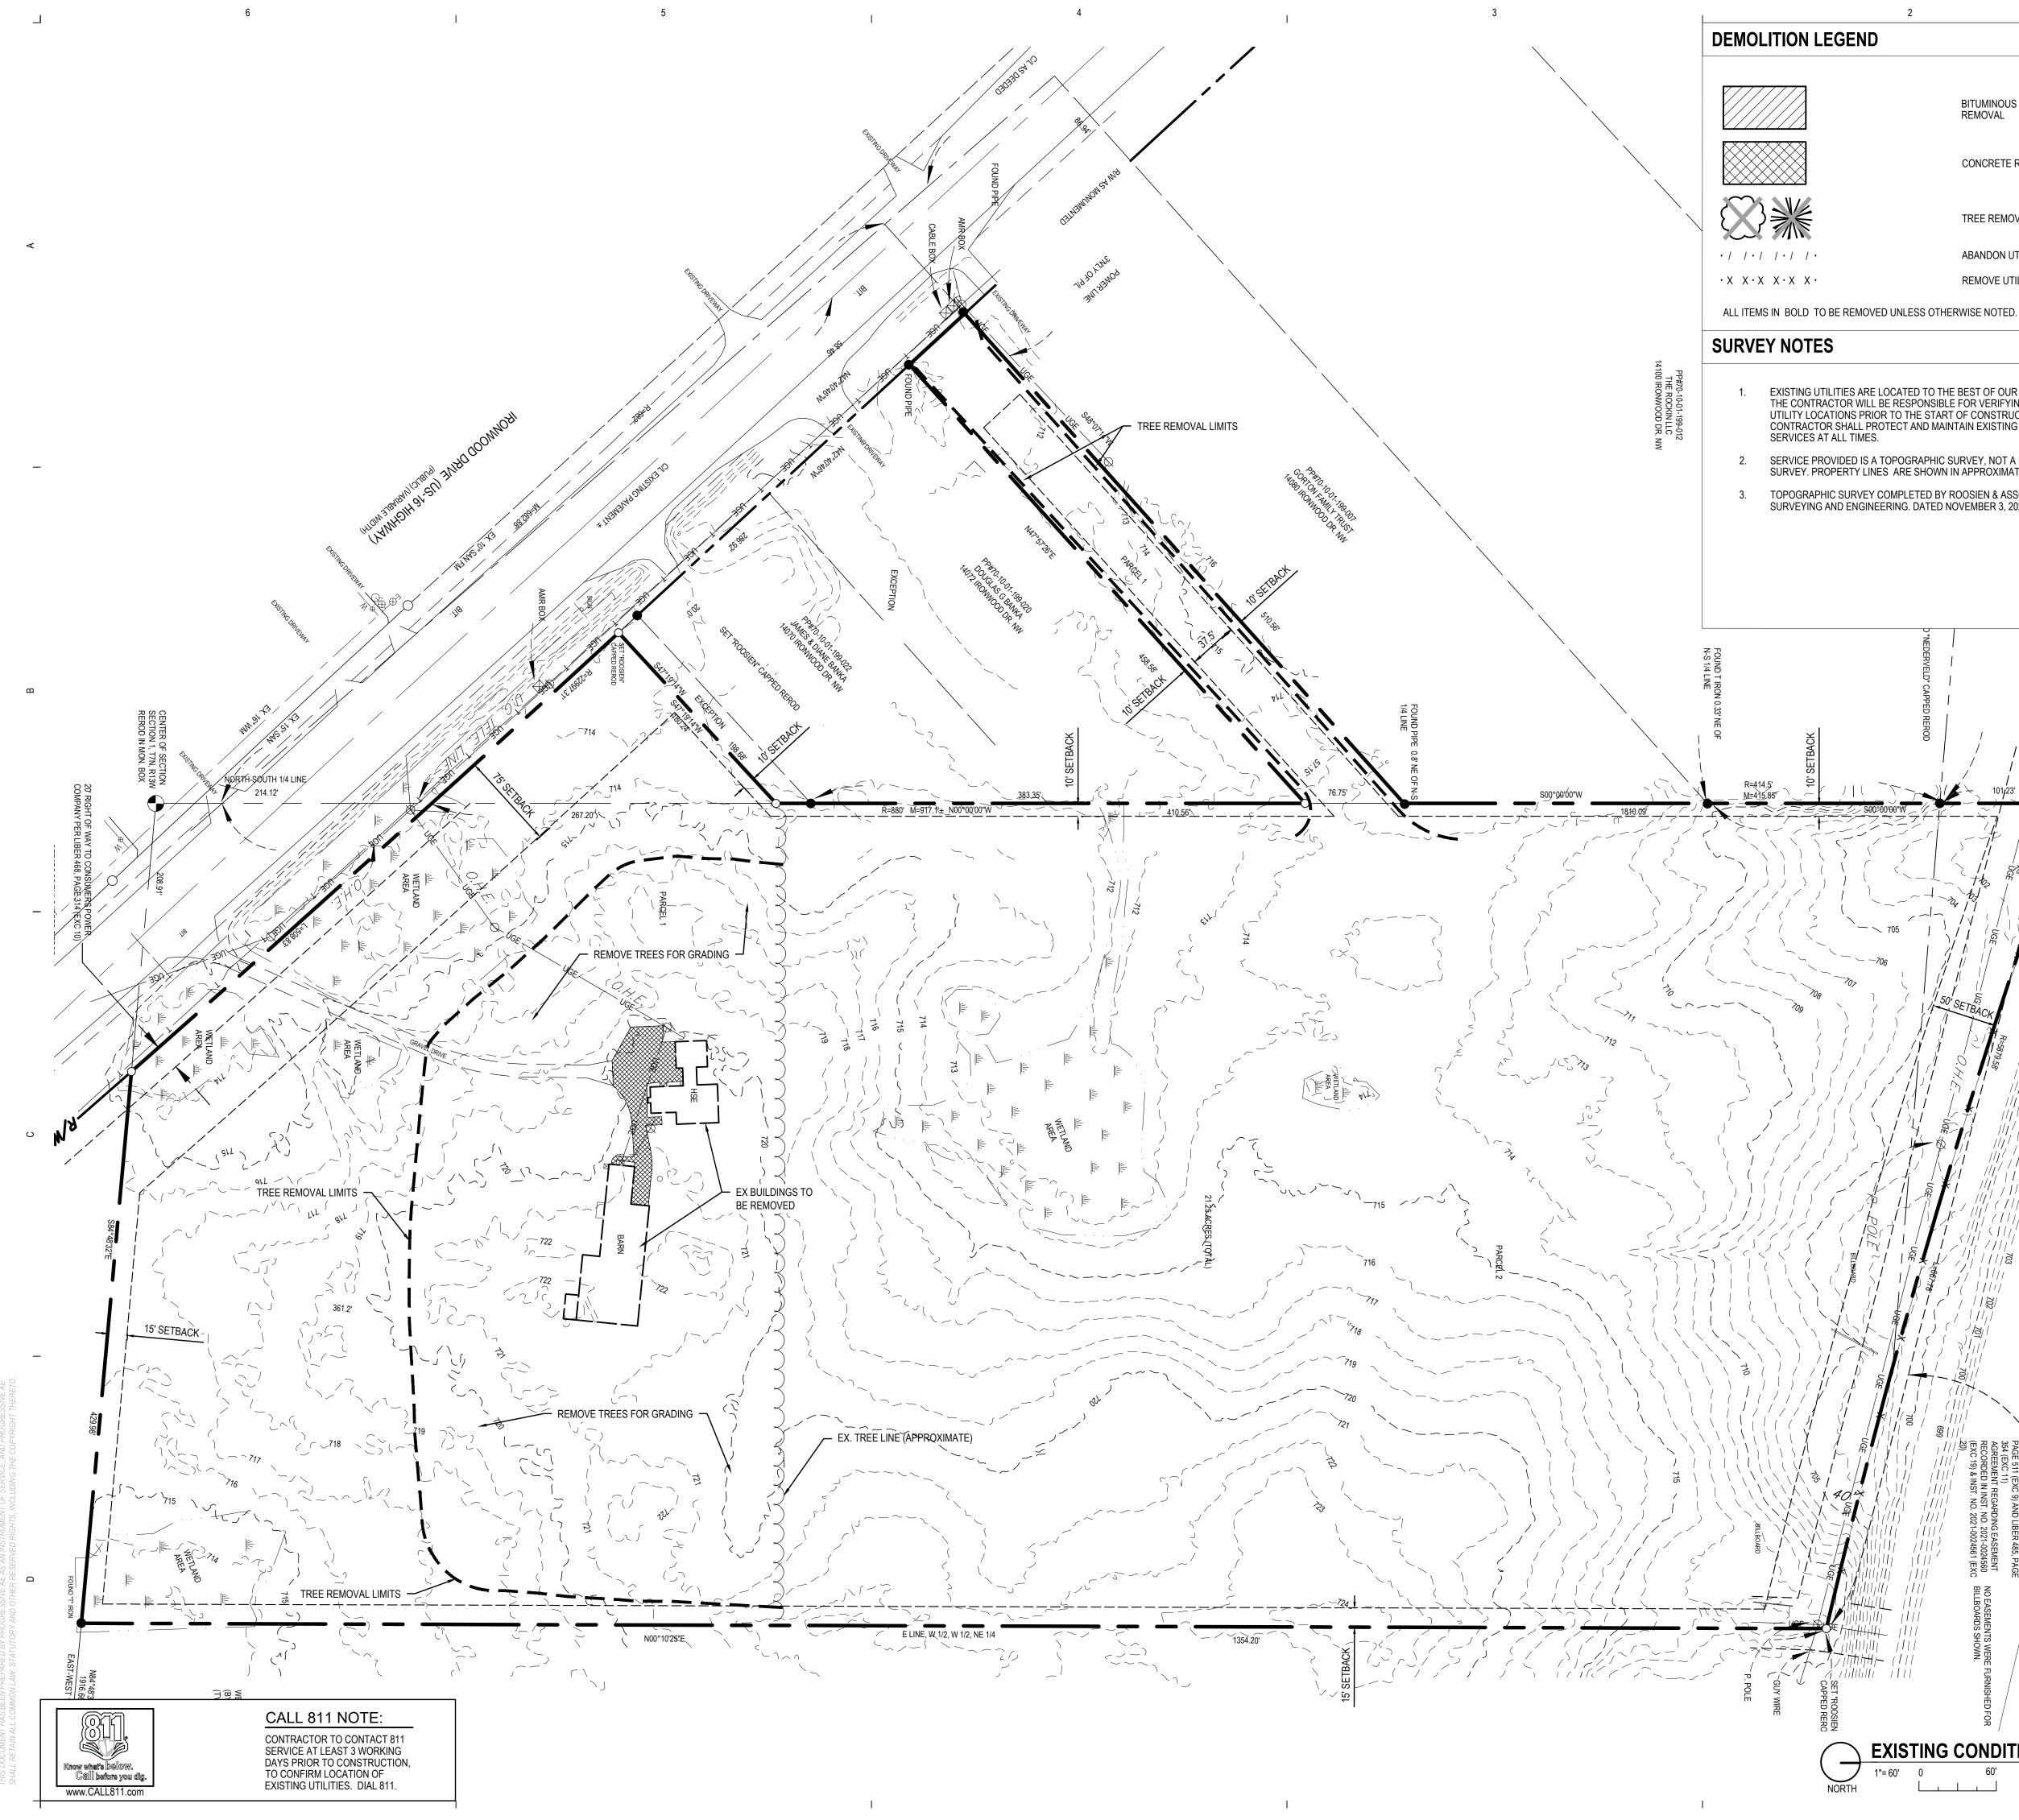
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ISSUANCE 06/09/2022 SITE PLAN RESUBMITTAL

PROJECT NUMBER 73680011 PROJECT MANAGER S. TEITSMA PROFESSIONAL L. SCHANER DRAWN BY D. WILLETT CHECKED BY

COVER SHEET

G001



#### BITUMINOUS PAVEMENT REMOVAL

CONCRETE REMOVAL

TREE REMOVAL

ABANDON UTILITY LINE

REMOVE UTILITY LINE

EXISTING UTILITIES ARE LOCATED TO THE BEST OF OUR KNOWLEDGE. THE CONTRACTOR WILL BE RESPONSIBLE FOR VERIFYING EXISTING UTILITY LOCATIONS PRIOR TO THE START OF CONSTRUCTION. THE

CONTRACTOR SHALL PROTECT AND MAINTAIN EXISTING UTILITY

SERVICE PROVIDED IS A TOPOGRAPHIC SURVEY, NOT A BOUNDARY SURVEY. PROPERTY LINES ARE SHOWN IN APPROXIMATE LOCATION

TOPOGRAPHIC SURVEY COMPLETED BY ROOSIEN & ASSOCIATES SURVEYING AND ENGINEERING. DATED NOVEMBER 3, 2020

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MONUMENT PROPERTY IRON SET PROPERTY IRON FOUND TRAFFIC SIGNAL POLE BOLLARD LIGHT LIGHT POLE FLOOD LIGHT SIGN FLAG POLE CLEANOUT POWER POLE TELEPHONE POLE ELECTRICAL HAND HOLE TEL., ELEC., CATV, GAS, WATER RISER TEL., ELEC., GAS, WATER MANHOLE TEL., ELEC., CATV, GAS MARKER CATCH BASIN MANHOLE SPRINKLER VALVE & BOX HYDRANT SPOT ELEVATION MAJOR CONTOUR - 5 FT. INTERVAL MINOR CONTOUR - 1 FT. INTERVAL GUARD RAIL FENCE LINE STORM SEWER SANITARY SEWER WATERMAIN GAS MAIN UNDERGROUND TELEPHONE LINE UNDERGROUND FIBER OPTIC LINE UNDERGROUND ELECTRIC LINE DITCH CENTERLINE, TOE OF SLOPE DECIDUOUS TREE CONIFEROUS TREE

TREE & BRUSH LINE

BUILDING

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PROJECT NUMBER 73680011 PROJECT MANAGER S. TEITSMA PROFESSIONAL L. SCHANER DRAWN BY A. ZIEBELL CHECKED BY

EXISTING CONDITIONS C101


#### SURVEY LEGEND


#### SITE CLEARING AND DEMOLITION NOTES

- THE CONTRACTOR SHALL BE RESPONSIBLE FOR VISITING THE SITE AND BECOMING FAMILIAR WITH THE DEMOLITION AND CLEARING REQUIREMENTS.
- NO REMOVAL, DEMOLITION, CLEARING OR TOPSOIL REMOVAL SHALL OCCUR ON SITE UNTIL THE SESC AND STORMWATER PERMITS HAVE BEEN ISSUED AND THE CONTRACTOR HAS VERIFIED AND STAKED THE LIMITS OF REMOVAL IN THE FIELD. NOTIFY SITE CONSULTANT OF THE START OF CONSTRUCTION AND DATE WHEN THE LIMITS LINE WILL BE ESTABLISHED FOR REVIEW AND APPROVAL.
- ALL MATERIALS NOTED TO BE SALVAGED SHALL BE TURNED OVER TO THE OWNER OR REINSTALLED ON SITE AS NOTED.
- NO BURNING OR BURYING OF CLEARED OR DEMOLITION MATERIAL SHALL BE ALLOWED ON SITE.
- REMOVE ALL STRUCTURES, FOUNDATIONS, BITUMINOUS PAVEMENT, CONCRETE SIDEWALK STEPS AND OTHER EXISTING SITE FEATURES AS INDICATED ON THE DRAWINGS. ALSO, REMOVE ALL DEBRIS FROM WITHIN CONSTRUCTION LIMITS ON SITE. ALL DEMOLITION MATERIALS SHALL BE REMOVED FROM THE SITE AND, UNLESS OTHERWISE NOTED, DISPOSED OF IN A MANNER ACCEPTABLE TO LOCAL JURISDICTION HAVING AUTHORITY.
- THE CONTRACTOR SHALL BE LICENSED BY THE STATE OF MICHIGAN FOR DEMOLITION REMOVAL AND HAULING OF MATERIALS.
- THE CONTRACTOR IS RESPONSIBLE TO OBTAIN ALL PERMITS AND FEES FOR THIS WORK.
- EXISTING UTILITIES ARE LOCATED TO THE BEST OF OUR KNOWLEDGE. THE CONTRACTOR WILL BE RESPONSIBLE FOR VERIFYING EXISTING UTILITY LOCATIONS PRIOR TO THE START OF CONSTRUCTION. THE CONTRACTOR SHALL PROTECT AND MAINTAIN EXISTING UTILITY SERVICES AT ALL TIMES.
- ALL EXCESS OR UNSUITABLE TOPSOIL OR SUBSOIL TO BECOME THE PROPERTY OF THE CONTRACTOR AND REMOVED OFFSITE.
- PROTECT EXISTING TREES UNLESS OTHERWISE NOTED. NO PARKING 10. OR STORAGE OF MATERIALS WITHIN TREE ROOT ZONE. PLACE TREE PROTECTION FENCE WHERE SHOWN ON PLAN.
- 11. CONTRACTOR TO CALL 811 AT LEAST 3 WORKING DAYS PRIOR TO CONSTRUCTION, TO CONFIRM LOCATION OF EXISTING UTILITIES.
- CONTRACTOR MUST RESTORE AND REPAIR ANY EXISTING CONDITIONS 12. DISTURBED BY CONSTRUCTION.
- ANY AREA DISTURBED BY CONSTRUCTION TO BE RESTORED TO 13. CONDITION EQUAL TO OR BETTER THAN BEFORE CONSTRUCTION BEGAN. PATCH PAVEMENT IN-KIND IF REQUIRED.
- 14. SAWCUT FULL DEPTH ALL EDGES OF PAVEMENT TO BE REMOVED. 15. ALL GROUND AREAS DISTURBED BY CONSTRUCTION TO BE TOPSOILED AND SEEDED PER THE SITE LANDSCAPE PLAN UNLESS SHOWN OTHERWISE ON PLANS.

**EXISTING CONDITIONS** 60 1"= 60'

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#### Know wh**at's** below. Câll before you dig. www.CALL811.com
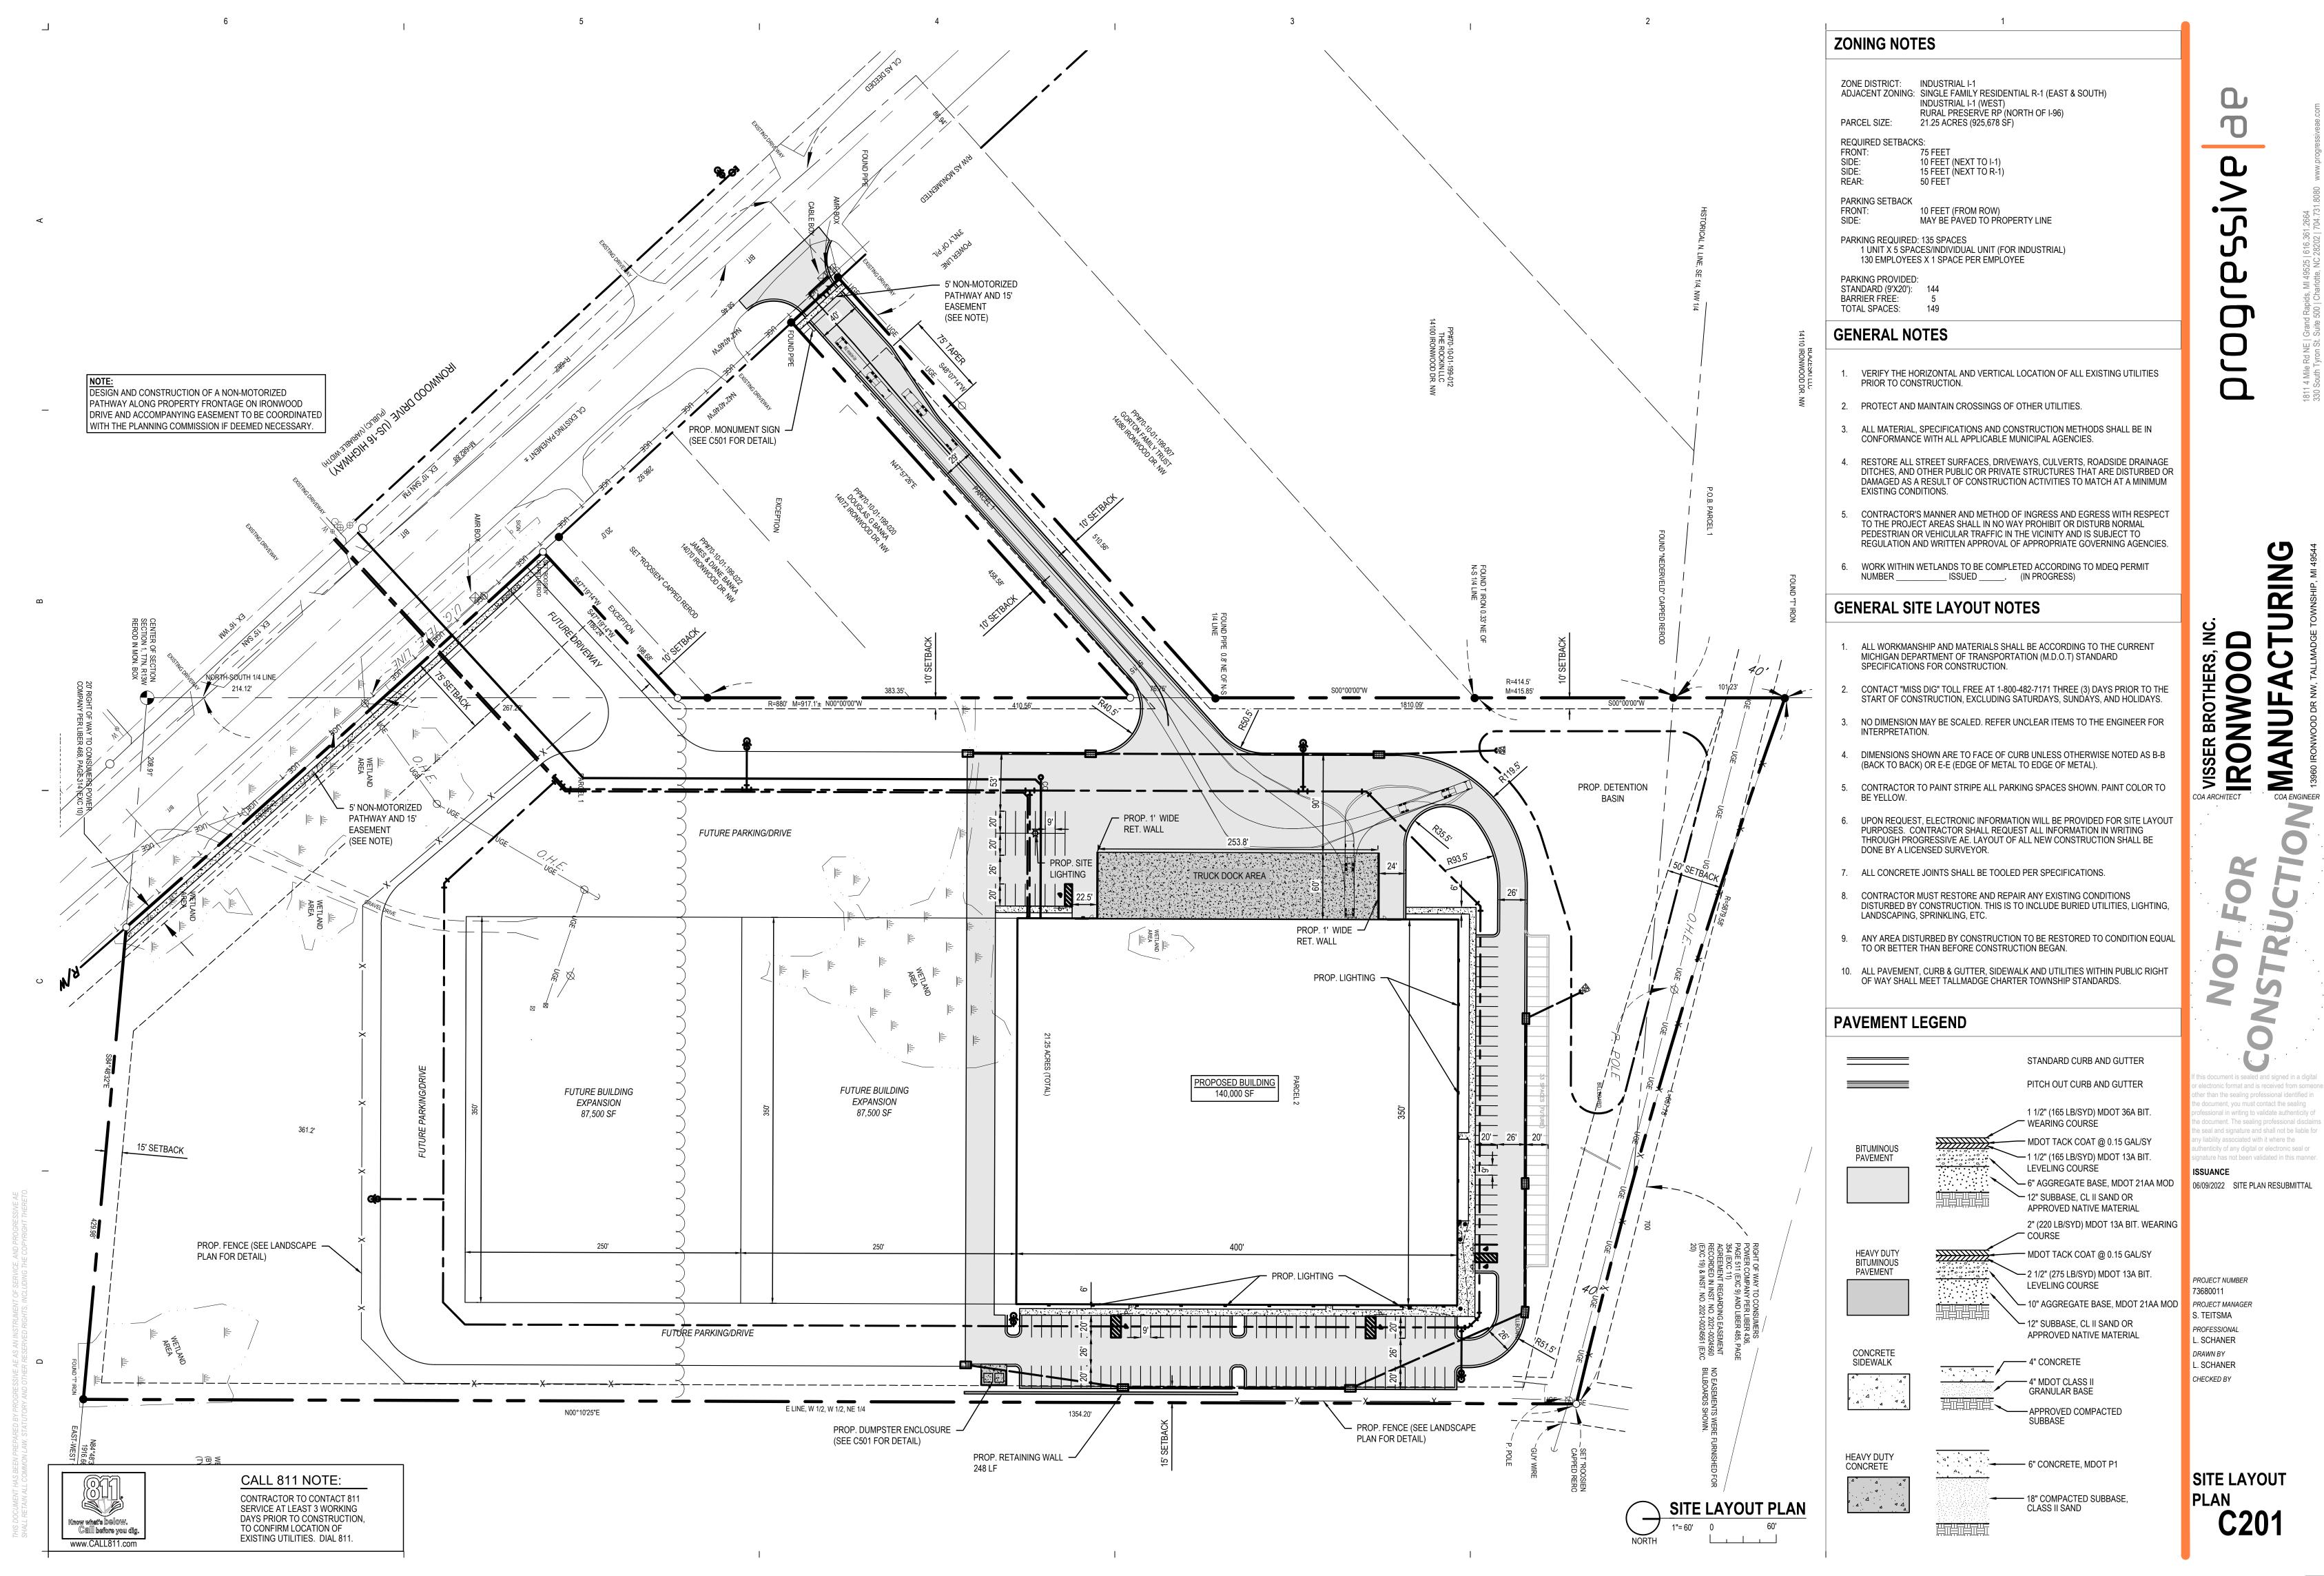
#### CALL 811 NOTE:
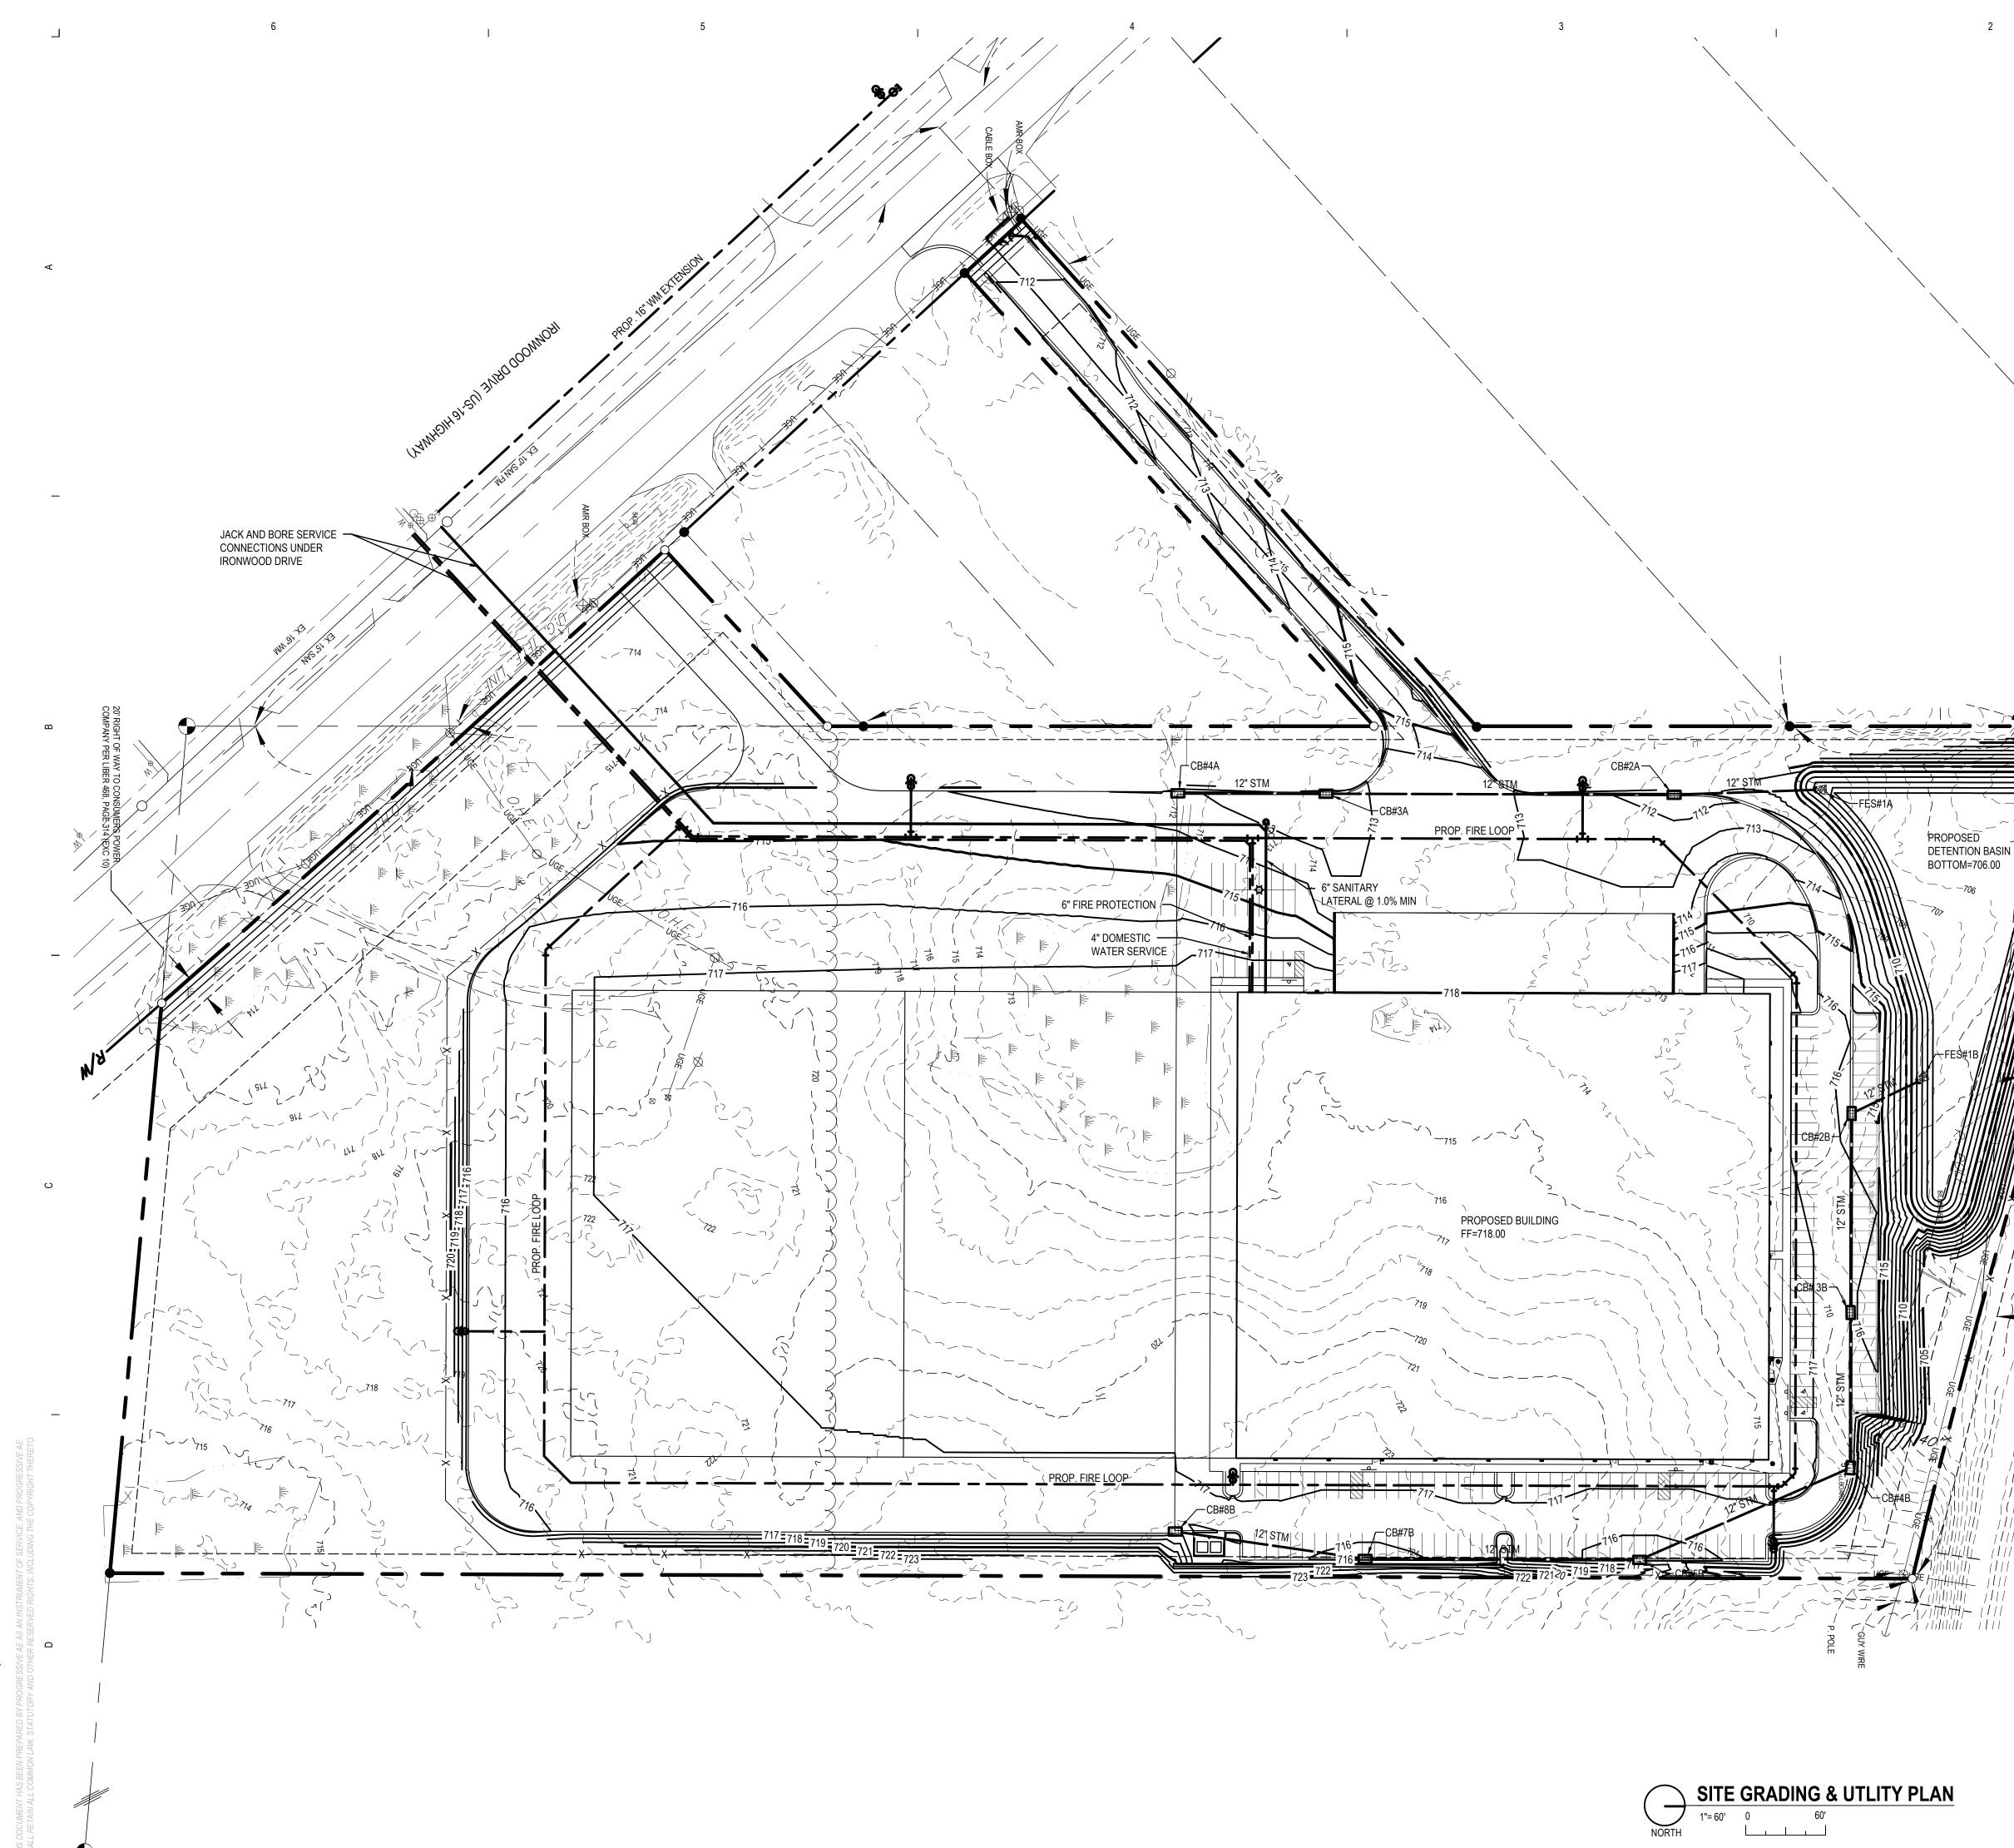
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## **GRADING LEGEND**

	FLOW ARROW
TP	TOP OF PAVEMENT
TC	TOP OF CURB
TW	TOP OF WALL
BW	BOTTOM OF WALL
GR	GROUND
GP	GUTTER PAN
FF	FINISH FLOOR ELEVATION
EX	EXISTING ELEVATION
HP	HIGH POINT
LP	LOW POINT
L	LANDING
R	RAMP

## **BARRIER FREE NOTES**

40'

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- BARRIER FREE PARKING AND ACCESSIBLE ROUTE(S) MUST COMPLY WITH THE AMERICANS WITH DISABILITIES ACT, INCLUDING BUT NOT LIMITED TO THE FOLLOWING:
- 2. 2% MAXIMUM CROSS SLOPE ON ACCESSIBLE ROUTE(S)
- 5% MAXIMUM LONGITUDINAL SLOPE (DIRECTION OF TRAVEL) UNLESS AT BARRIER FREE RAMP
- 2% MAXIMUM SLOPE LONGITUDINAL AND TRANSVERSE SLOPES AT BARRIER FREE PARKING SPACES AND ASSOCIATED ACCESS AISLES
- ACCESSIBLE ENTRIES 2% MAXIMUM SLOPE IN ANY DIRECTION FOR THE FIRST 5' FROM ENTRY DOOR
- CONTRACTOR TO CONTACT ENGINEER PRIOR TO PAVING IF BARRIER FREE SLOPES DO NOT COMPLY OR FOR CLARIFICATION OF ANY DISCREPANCIES.


## EARTHWORK & GRADING NOTES

- EARTHWORK AND PAVEMENT CONSTRUCTION ARE TO BE PERFORMED IN ACCORDANCE WITH THE 2012 EDITION OF THE MDOT STANDARD SPECIFICATIONS FOR CONSTRUCTION UNLESS OTHERWISE NOTED IN THE FOLLOWING ITEMS.
- THE SUBGRADE SHALL BE THOROUGHLY PROOFROLLED USING THE EQUIVALENT OF A FULLY LOADED TANDEM AXLE TRUCK HAVING A MINIMUM AXLE WEIGHT OF 10 TONS. SOFT OR YIELDING AREAS THAT CANNOT BE MECHANICALLY STABILIZED SHOULD BE REMOVED AND REPLACED WITH ENGINEERED FILL.
- 3. PROOFROLLING SHALL BE PERFORMED UNDER THE OBSERVATION OF A GEOTECHNICAL/PAVEMENT ENGINEER.
- 4. FINISHED SUBGRADE SURFACE SHALL NOT BE MORE THAN 0.1 FEET ABOVE OR BELOW ESTABLISHED FINISHED SUBGRADE ELEVATIONS AND ALL GROUND SURFACES SHALL VARY UNIFORMLY BETWEEN INDICATED ELEVATIONS. FINISHED DITCHES SHALL BE GRADED TO ALLOW FOR PROPER DRAINAGE WITHOUT PONDING AND IN A MANNER THAT WILL MINIMIZE EROSION.
- 5. GRADE THE AGGREGATE BASE MATERIAL TO PROVIDE POSITIVE DRAINAGE AT A MINIMUM OF 1.5 PERCENT.
- 6. THE AGGREGATE BASE AND SUBBASE SHALL EXTEND 12 INCHES BEYOND THE PAVED EDGE.
- 7. THE EXISTING (SOIL TYPE) MAY BE UTILIZED AS ENGINEERED FILL PROVIDED ALL DELETERIOUS OR ORGANIC MATERIALS ARE REMOVED FROM THE SOILS. ANY ON-SITE SOILS USED FOR ENGINEERED FILL SHALL BE EVALUATED BY A GEOTECHNICAL ENGINEER PRIOR TO PLACEMENT.
- 8. ENGINEERED FILL LOCATED WITHIN PAVEMENT AND BUILDING AREAS SHALL BE PLACED IN 8 INCH MAXIMUM LOOSE THICKNESS AND MOISTURE CONDITIONED TO WITHIN 2 PERCENT OF OPTIMUM MOISTURE CONTENT. COMPACT TO MINIMUM OF 95 PERCENT OF THE MAXIMUM DRY DENSITY PER ASTM D-1557, MODIFIED PROCTOR METHOD
- ALL FILL OPERATIONS SHALL BE OBSERVED BY A QUALIFIED SOIL TECHNICIAN. A MINIMUM OF ONE COMPACTION TEST SHALL BE CONDUCTED PER 2,500 SFT AREA AT EACH LIFT. WITHIN TRENCH EXCAVATIONS, ONE TEST SHALL BE CONDUCTED FOR EACH 100 LINEAR FEET PER LIFT.
- 10. SIDE SLOPES SHALL NOT EXCEED 1 VERTICAL OVER 3 HORIZONTAL SLOPE UNLESS SHOWN OTHERWISE.
- 11. EXCESS TOPSOIL SHALL BE SPOILED ON SITE IN LOCATION DETERMINED WITH OWNER AND ENGINEER AND SEEDED.
- 12. PARKING LOT CURBS SHALL BE BUILT WITH REVERSE SLOPE ON THE DOWNHILL SIDE OF THE ISLAND TO ASSURE POSITIVE STORM WATER RUNOFF TO CATCH BASINS.
- 13. UNLESS SHOWN OTHERWISE, FINISH GRADES OF LAWN/LANDSCAPE ADJACENT TO BUILDING WALLS SHALL BE 6" BELOW FINISH FLOOR ELEVATION.
- 14. PLACE 4" MINIMUM TOPSOIL IN ALL LANDSCAPE AREAS TO BE SEEDED. PROVIDE POSITIVE DRAINAGE AT ALL TIMES TO ENSURE NO STANDING WATER WITHIN PAVEMENT, BUILDING PAD, OR GREEN AREAS.
- 15. FOR ALL CURB ISLANDS, CENTER OF ISLANDS TO BE A MINIMUM OF 6" HIGHER THAN TOP OF CURB.
- 16. THE SITE MAY BE DESIGNATED AS A FACILITY BECAUSE OF ENVIRONMENTAL IMPACTS. IN THE EVENT MATERIALS MUST BE REMOVED FROM THE SITE, TRANSPORTATION, HANDLING AND DISPOSAL OF EXCAVATED SOIL MATERIALS SHOULD BE PERFORMED IN ACCORDANCE WITH APPLICABLE ENVIRONMENTAL REGULATIONS.

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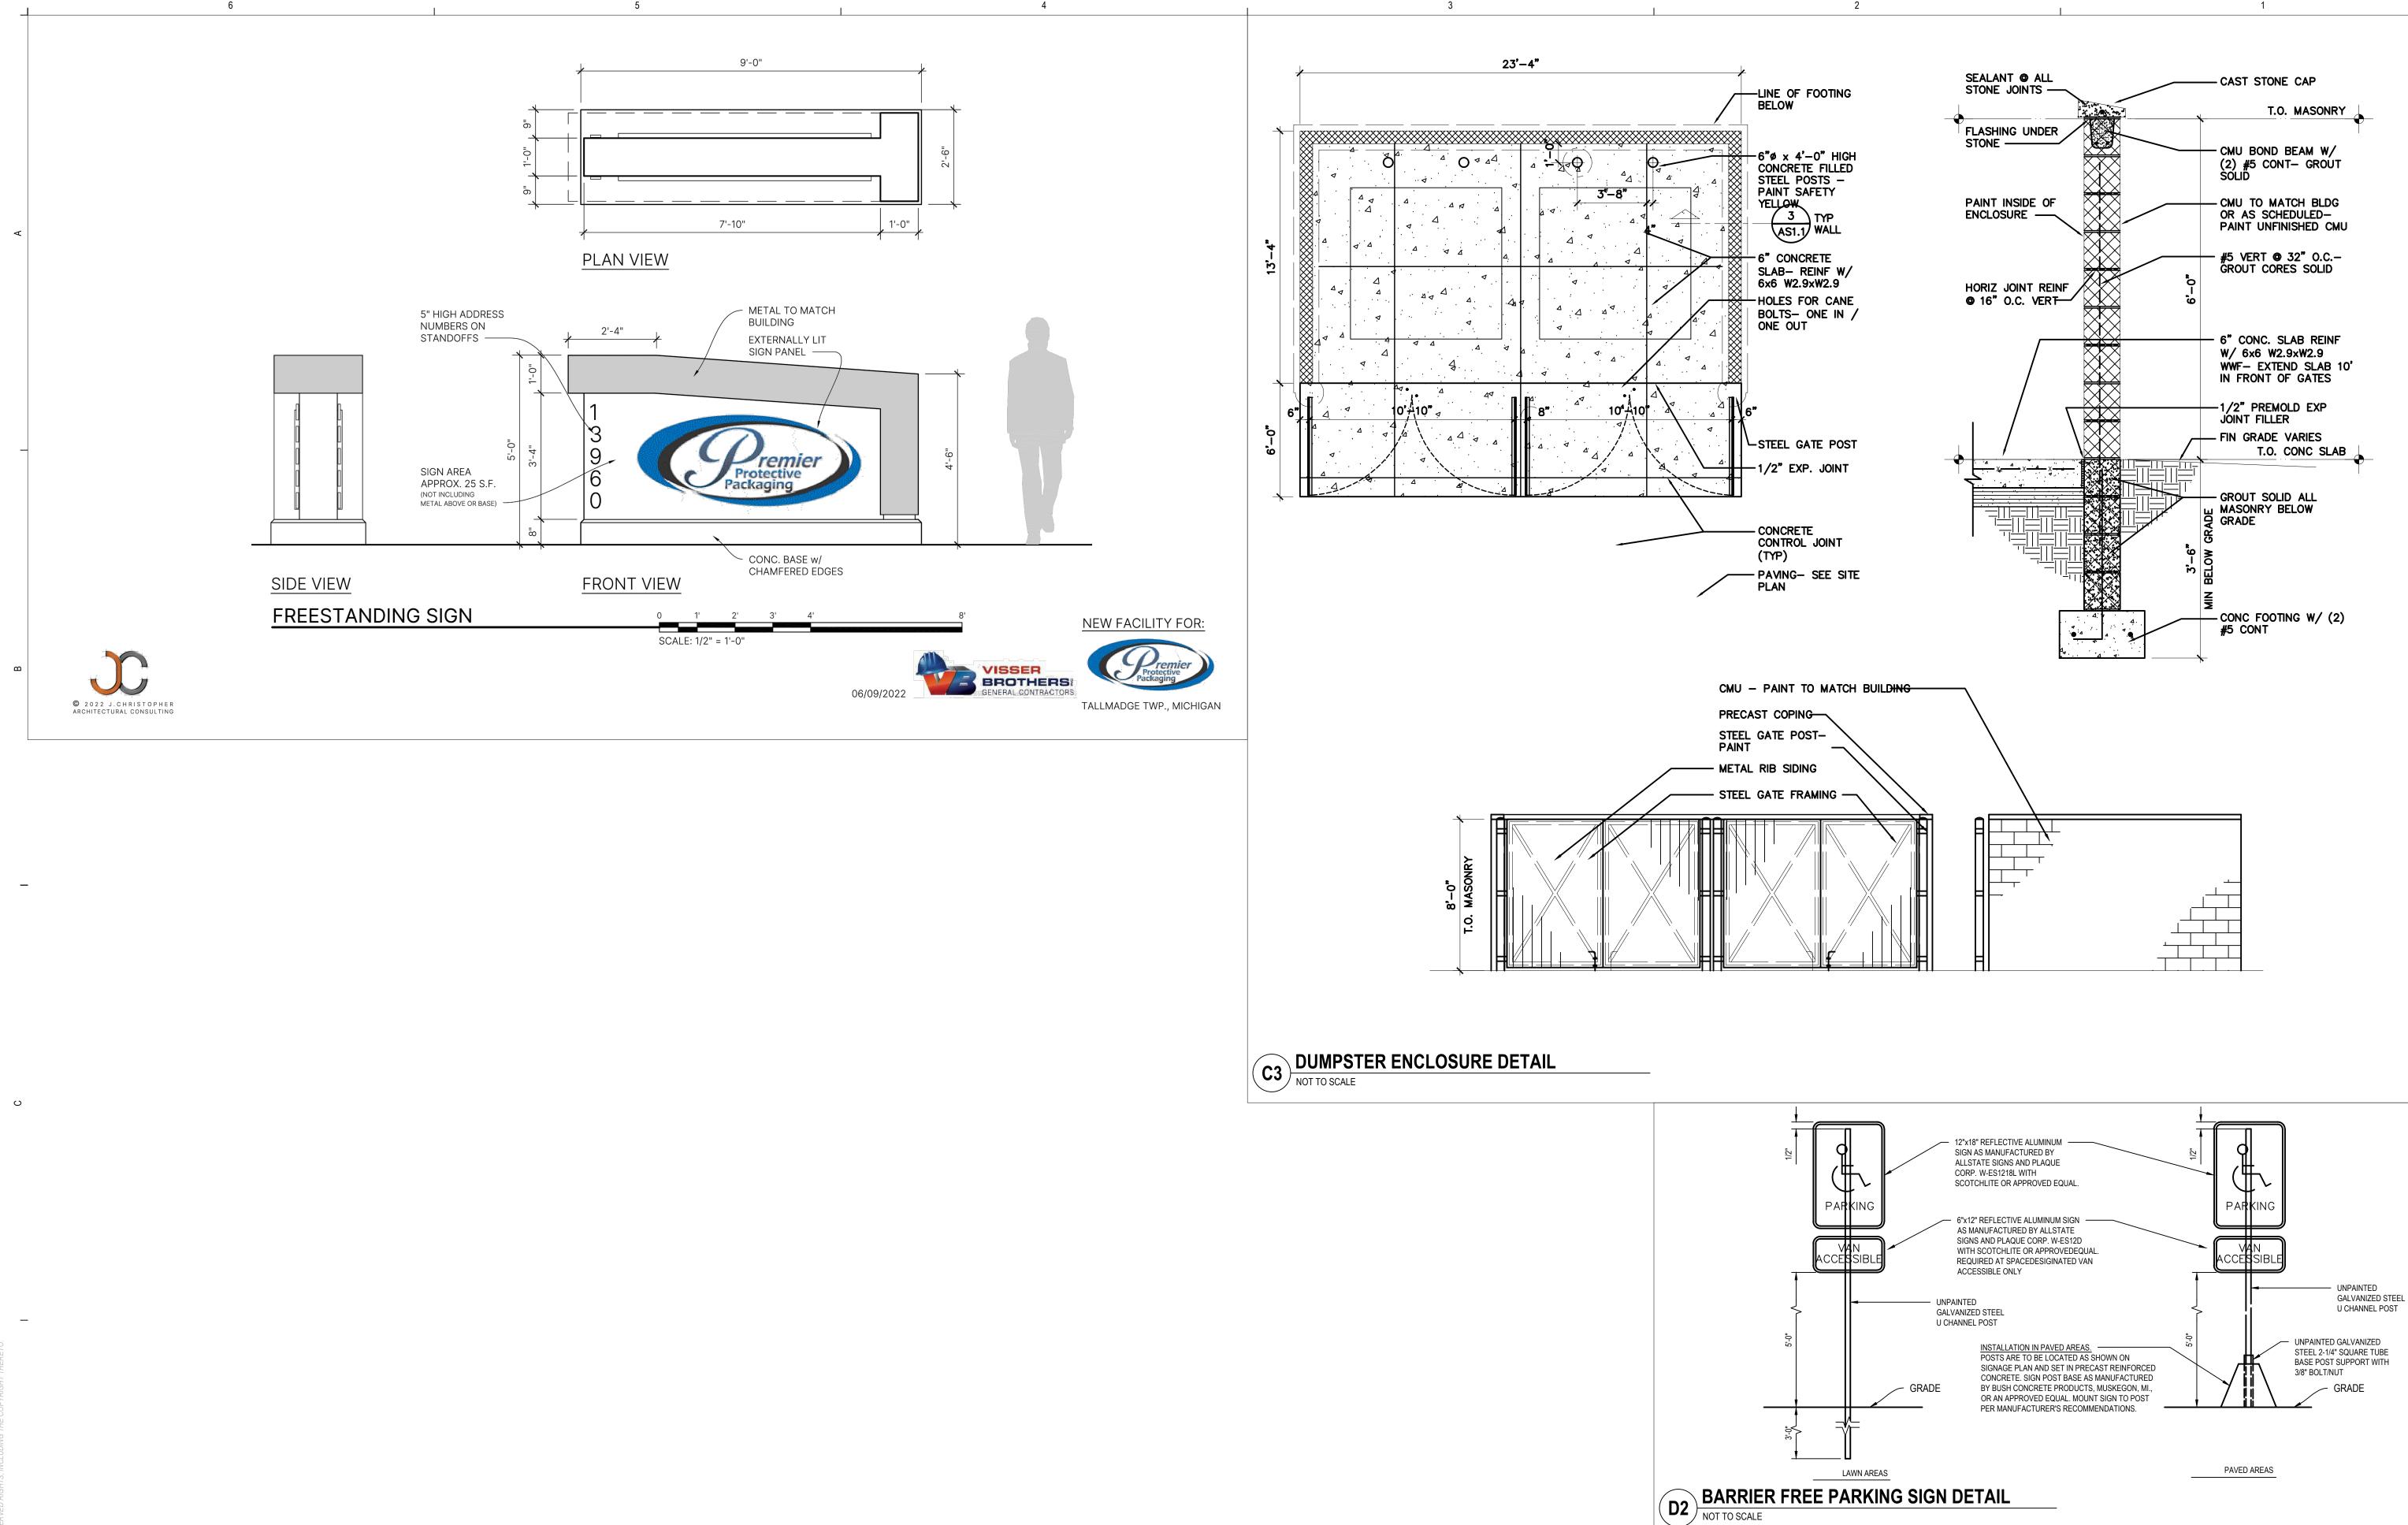



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06/09/2022 SITE PLAN RESUBMITTAL

PROJECT NUMBER 73680011 PROJECT MANAGER S. TEITSMA PROFESSIONAL L. SCHANER DRAWN BY D. WILLETT CHECKED BY

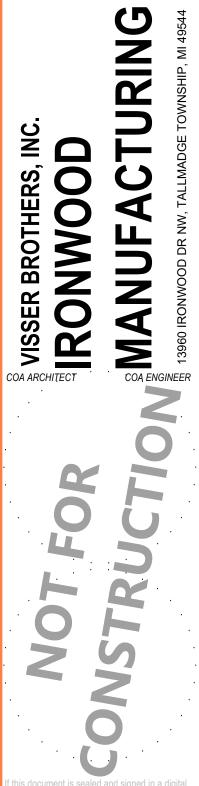SITE GRADING & UTLITY PLAN C301



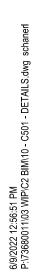

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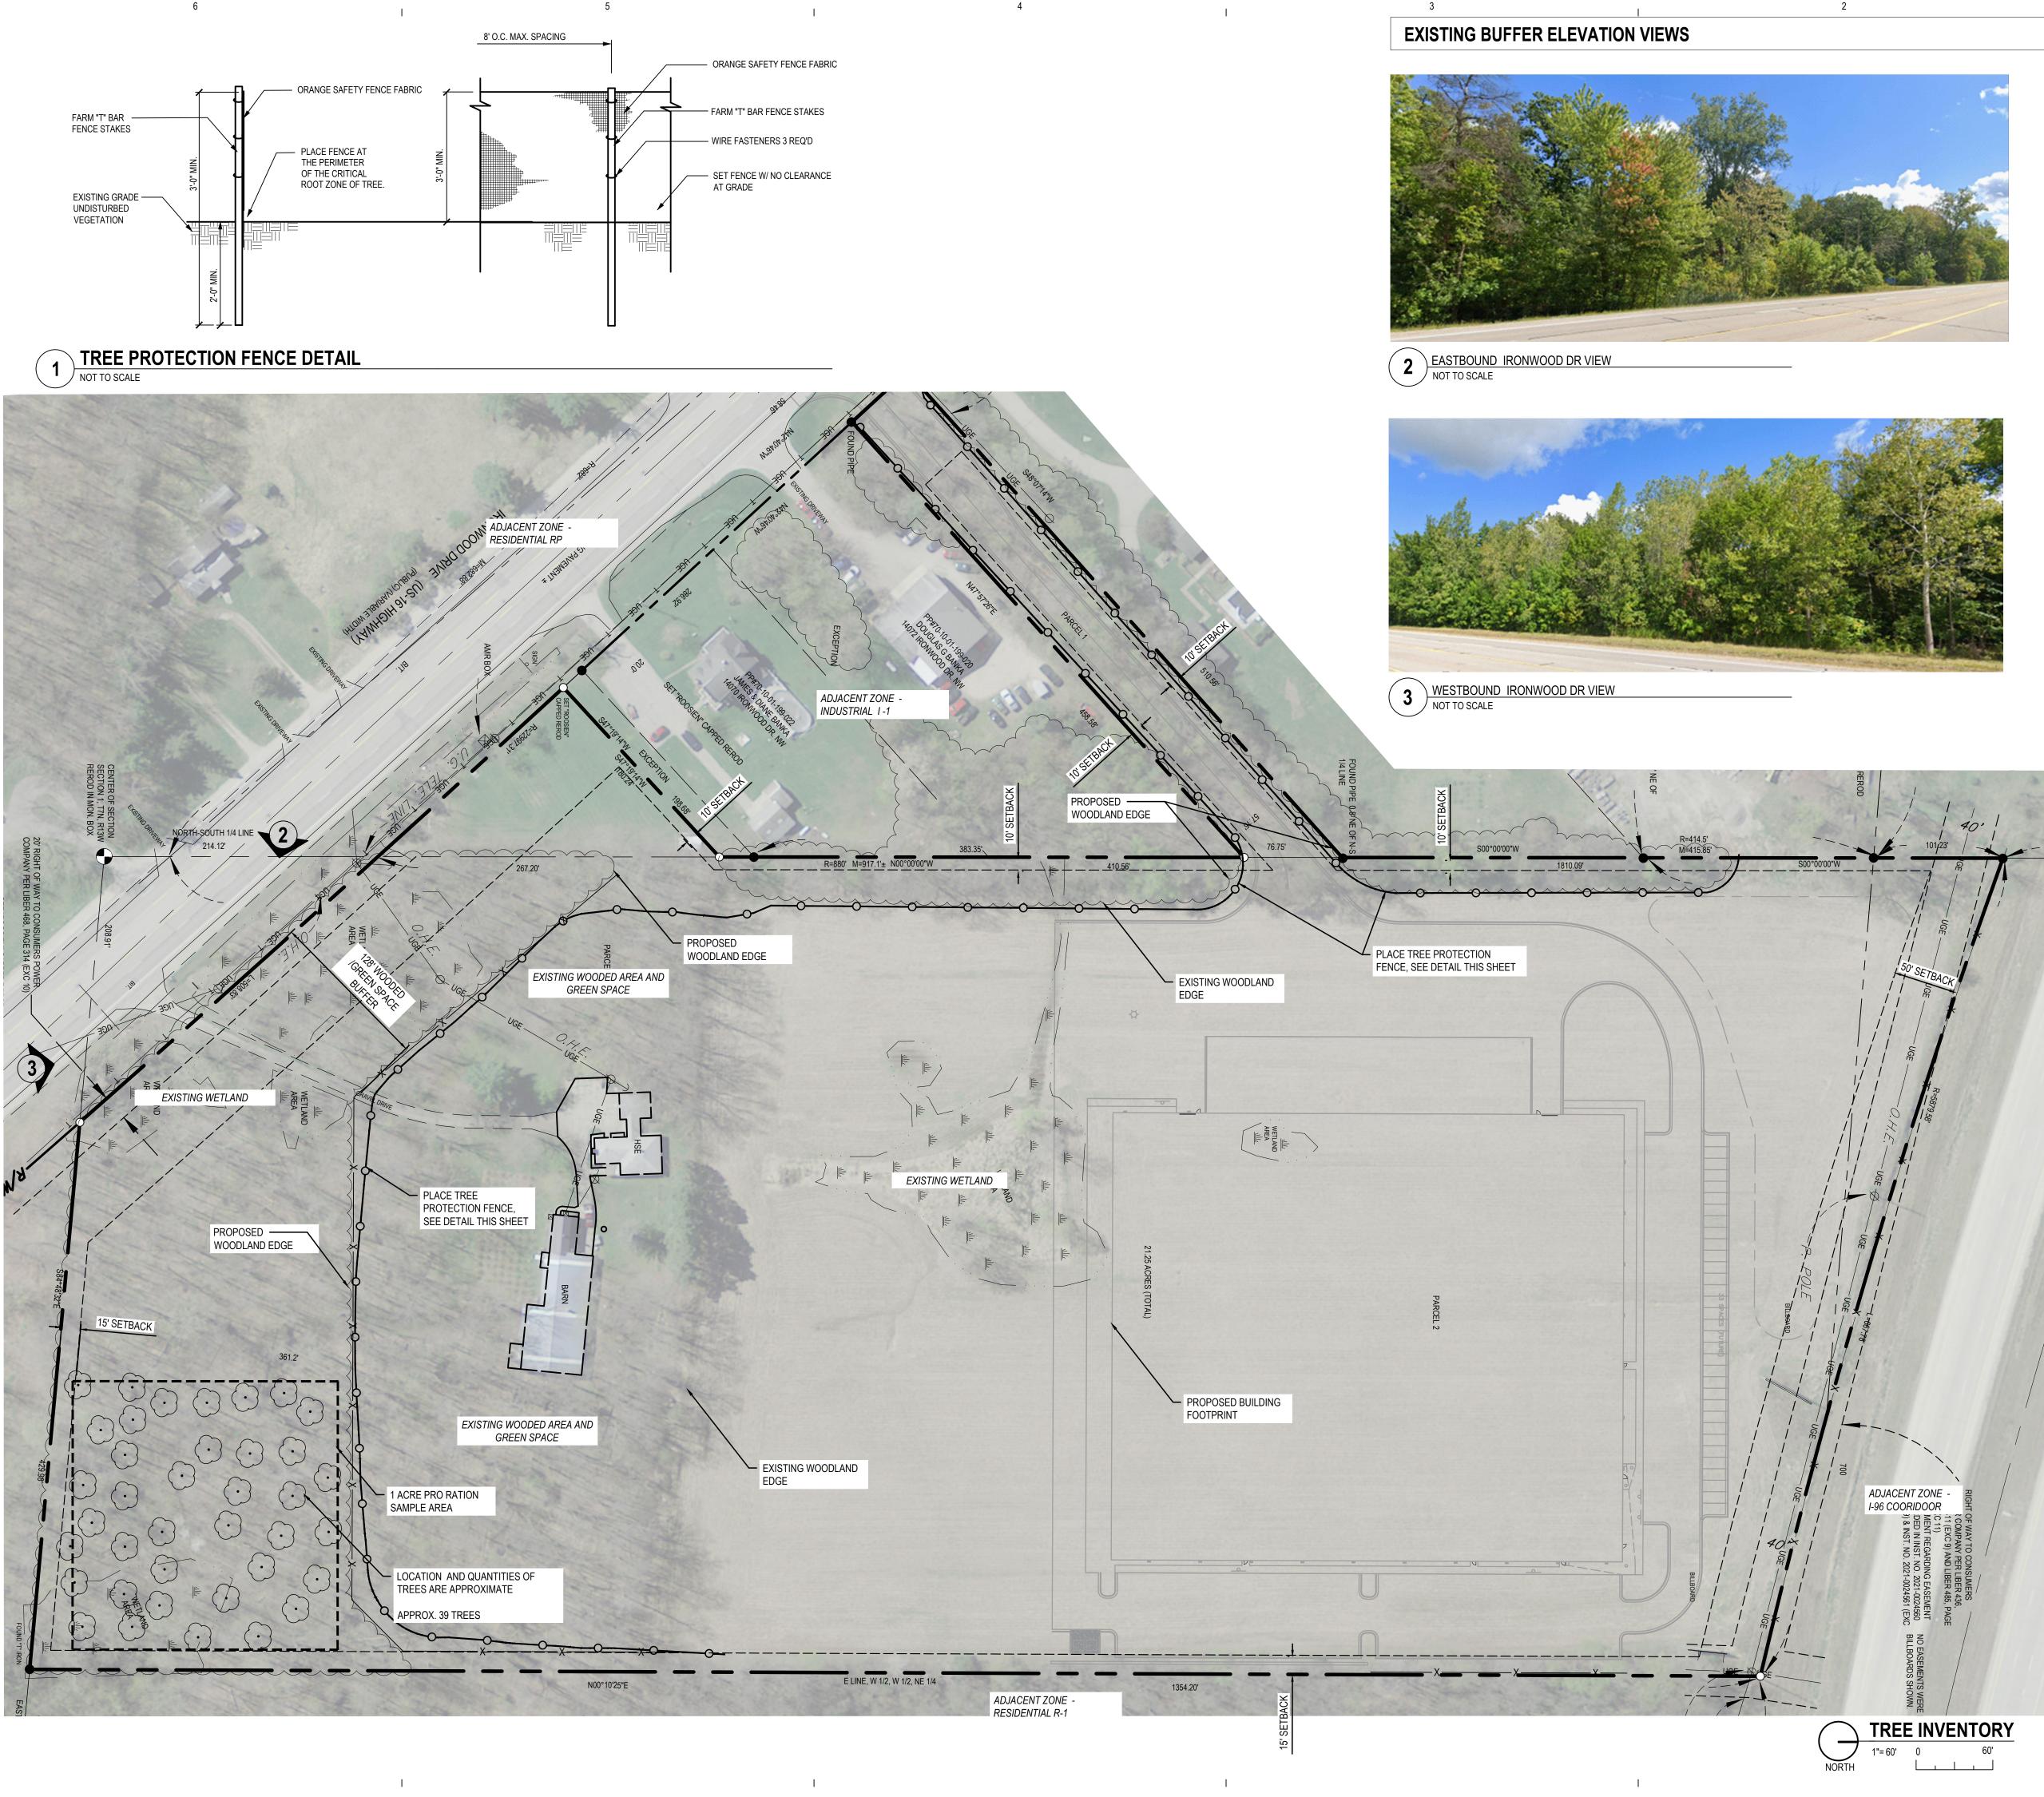
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06/09/2022 SITE PLAN RESUBMITTAL

PROJECT NUMBER 73680011 PROJECT MANAGER S. TEITSMA PROFESSIONAL L. SCHANER DRAWN BY L. SCHANER CHECKED BY

DETAILS C501

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TREE INVENTORY LEGEND



EXISTING TREES >6" CAL.

CALL 811 NOTE:

CONTRACTOR TO CONTACT 811 SERVICE AT LEAST 3 WORKING DAYS PRIOR TO CONSTRUCTION, TO CONFIRM LOCATION OF EXISTING UTILITIES. DIAL 811.

PROPOSED WOODLAND EDGE

1 ACRE PRO RATION SAMPLE AREA

-O------ TREE PROTECTION FENCE

#### TREE INVENTORY GENERAL NOTES

- ≈35-45 STEMS ( >6" CAL. TREES) PER ACRE DENSITY FOREST (LOCATION AND NUMBER APPROXIMATE)
- FOREST IS CLASSIFIED AS A NATIVE MESIC SOUTHERN FOREST OR A BEECH SUGAR MAPLE FOREST.
- WOODED AREA IS MODERATE DENSITY TREES AND HERBACEOUS UNDER STORY. WOODED AREA PROVIDES 100% VISUAL SCREENING.

#### **EXISTING TREE SPECIES**

DOMINATE TREE SPECIES PRESENT (BUT NOT LIMITED TOO)

SCIENTIFIC NAME Acer saccharum Acer rubrum Carpinus carolniana Fagus grandfolia Liriodendron tulipifera Ostrya virginana Quercus alba Quercus rubra Tilia americana

COMMON NAME
Sugar Maple
Red Maple
Musclewood
American Beech
Tulip Tree Ironwood
White Oak
Red Oak
Basswood

#### TREE PROTECTION GENERAL NOTES

- CONTRACTOR IS RESPONSIBLE FOR UNDERSTANDING PROJECT CONDITIONS. NOTIFY LANDSCAPE ARCHITECT OF PLAN DISCREPANCIES.
- PROTECT EXISTING TREES UNLESS OTHERWISE NOTED. NO PARKING OR STORAGE OF MATERIALS WITHIN TREE ROOT ZONE. PLACE TREE PROTECTION FENCE WHERE SHOWN ON PLAN.
- 3. TREE PROTECTION FENCE PER DETAIL, SEE THIS SHEET. INSTALL PRIOR TO ANY CONSTRUCTION ACTIVITY AND MAINTAIN DURING ENTIRE CONSTRUCTION PERIOD.
- 4. NO BURNING OR BURYING OF CLEARED OR DEMOLITION MATERIAL SHALL BE ALLOWED ON SITE.
- 5. CONTRACTOR MUST RESTORE AND REPAIR ANY EXISTING CONDITIONS DISTURBED BY CONSTRUCTION.

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06/09/2022 SITE PLAN RESUBMITTAL

TREE INVENTORY

ISSUANCE

PROJECT NUMBER

PROJECT MANAGER

73680011

S. TEITSMA

PROFESSIONAL B. SIMON DRAWN BY

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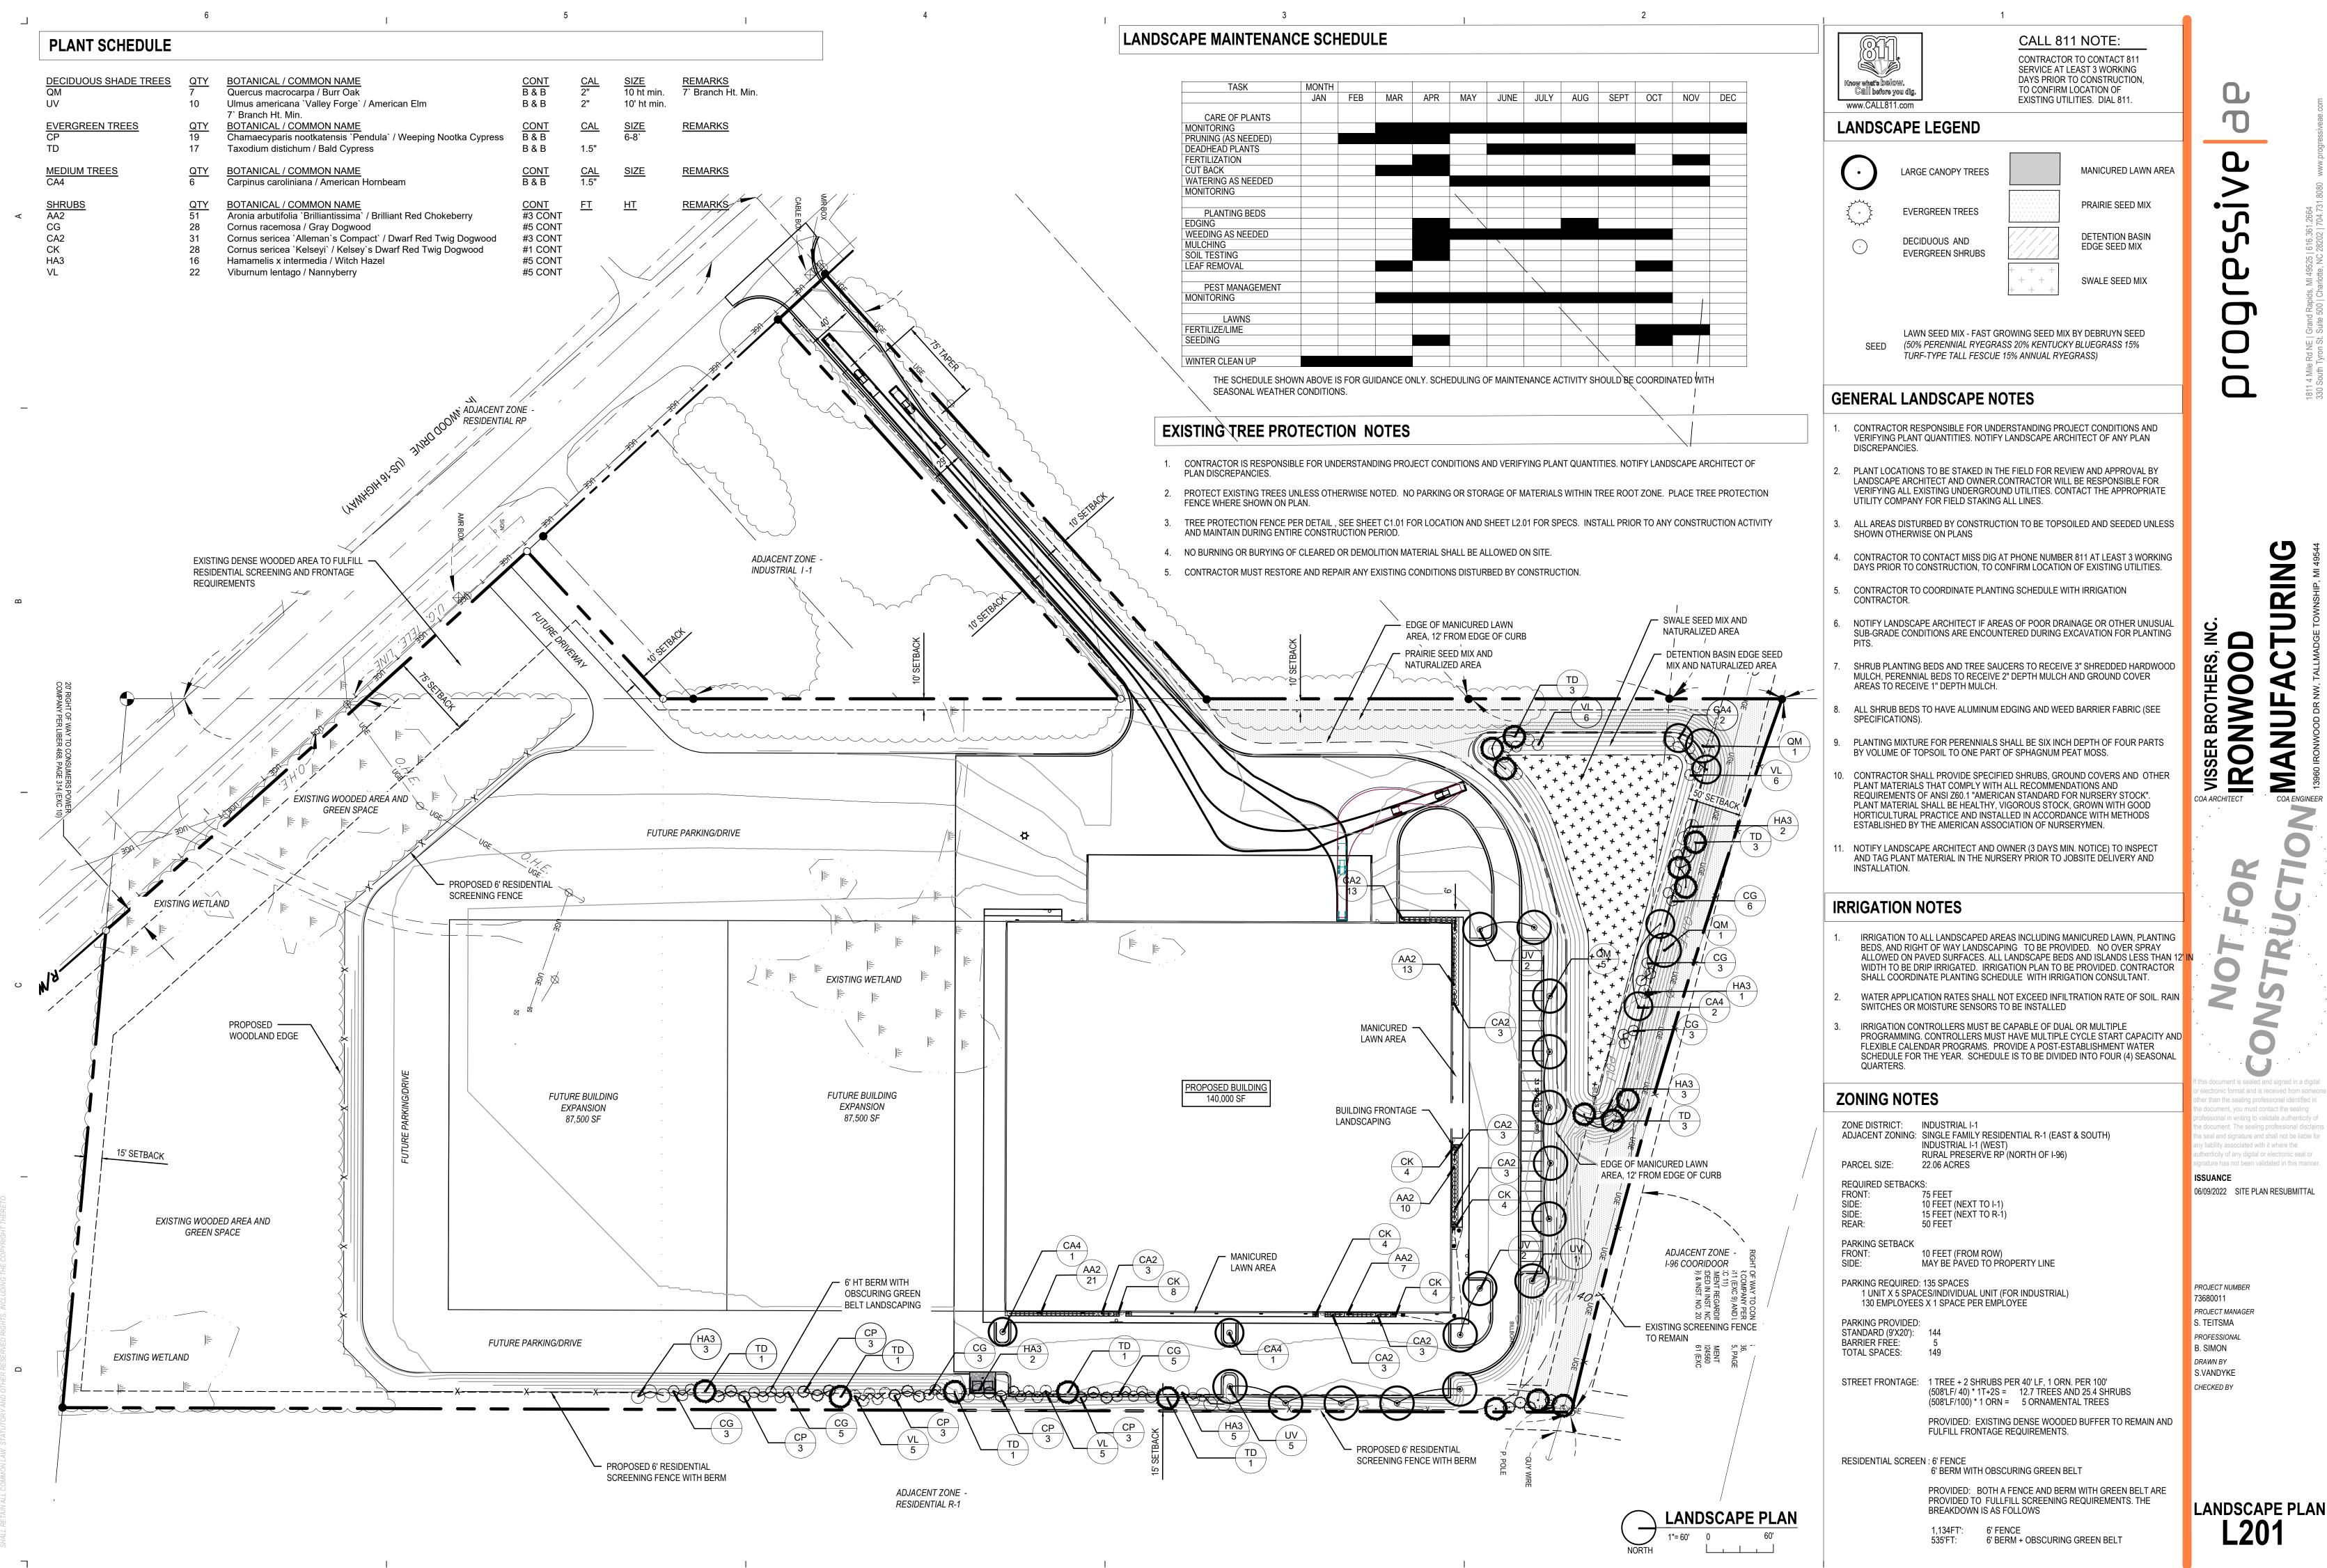
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VISSER BROTHERS, INC.

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## 6/9/2022 4:22:34 PM P://3680011/03 WIP/C2 BIM/11 - L301 - LANDSCAPE DETALS.dwg vandy

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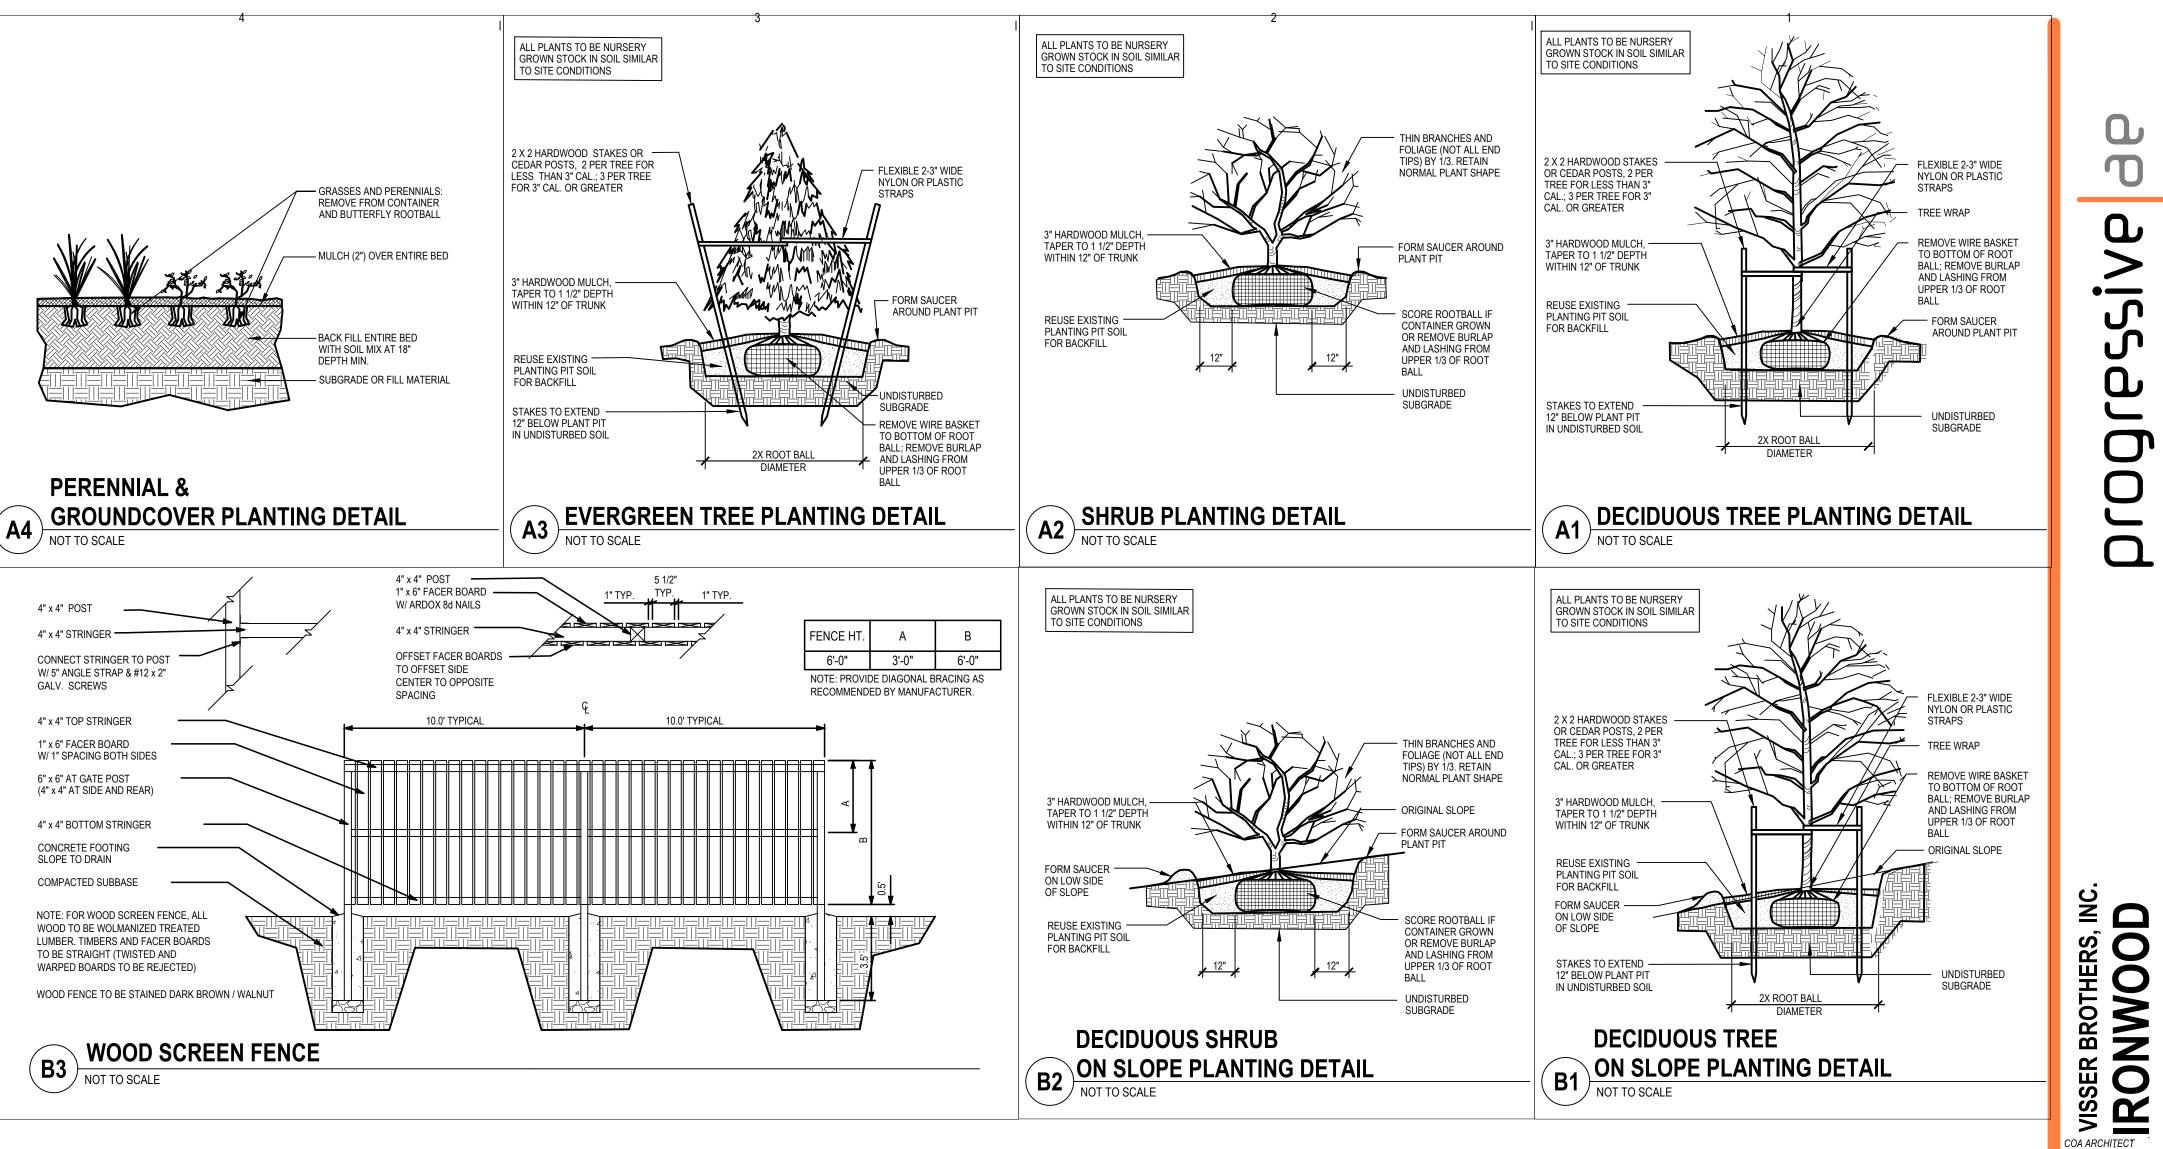
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SPACING "D"	ROW "A"	NO. OF PLANTS	AREA UNIT
6" O.C. 8" O.C.	5.2" 8.7"	4.61 1.66	1 SQ. FT.
8 0.C. 12" O.C. 18" O.C. 24" O.C.	10.4" 15.6" 20.8"	1.06 1.15 5.12 2.9	10 SQ. FT.
NOTES: 1. FOR USE ONL	Y WHEN PLANTS A	ARE SPACED EQUIDISTANCE	FROM EACH OTHER AS SHOWN
	AND GROUND COV ERWISE NOTED.	/ERS SHALL BE INSTALLED \	WITH TRIANGULAR SPACING
3. GROUND CO	VERS SHALL NOT E	BE PLANTED WITHIN 1' OF SI	HRUB AND TREE TRUNKS.
A5 PLAN		NG DETAIL	


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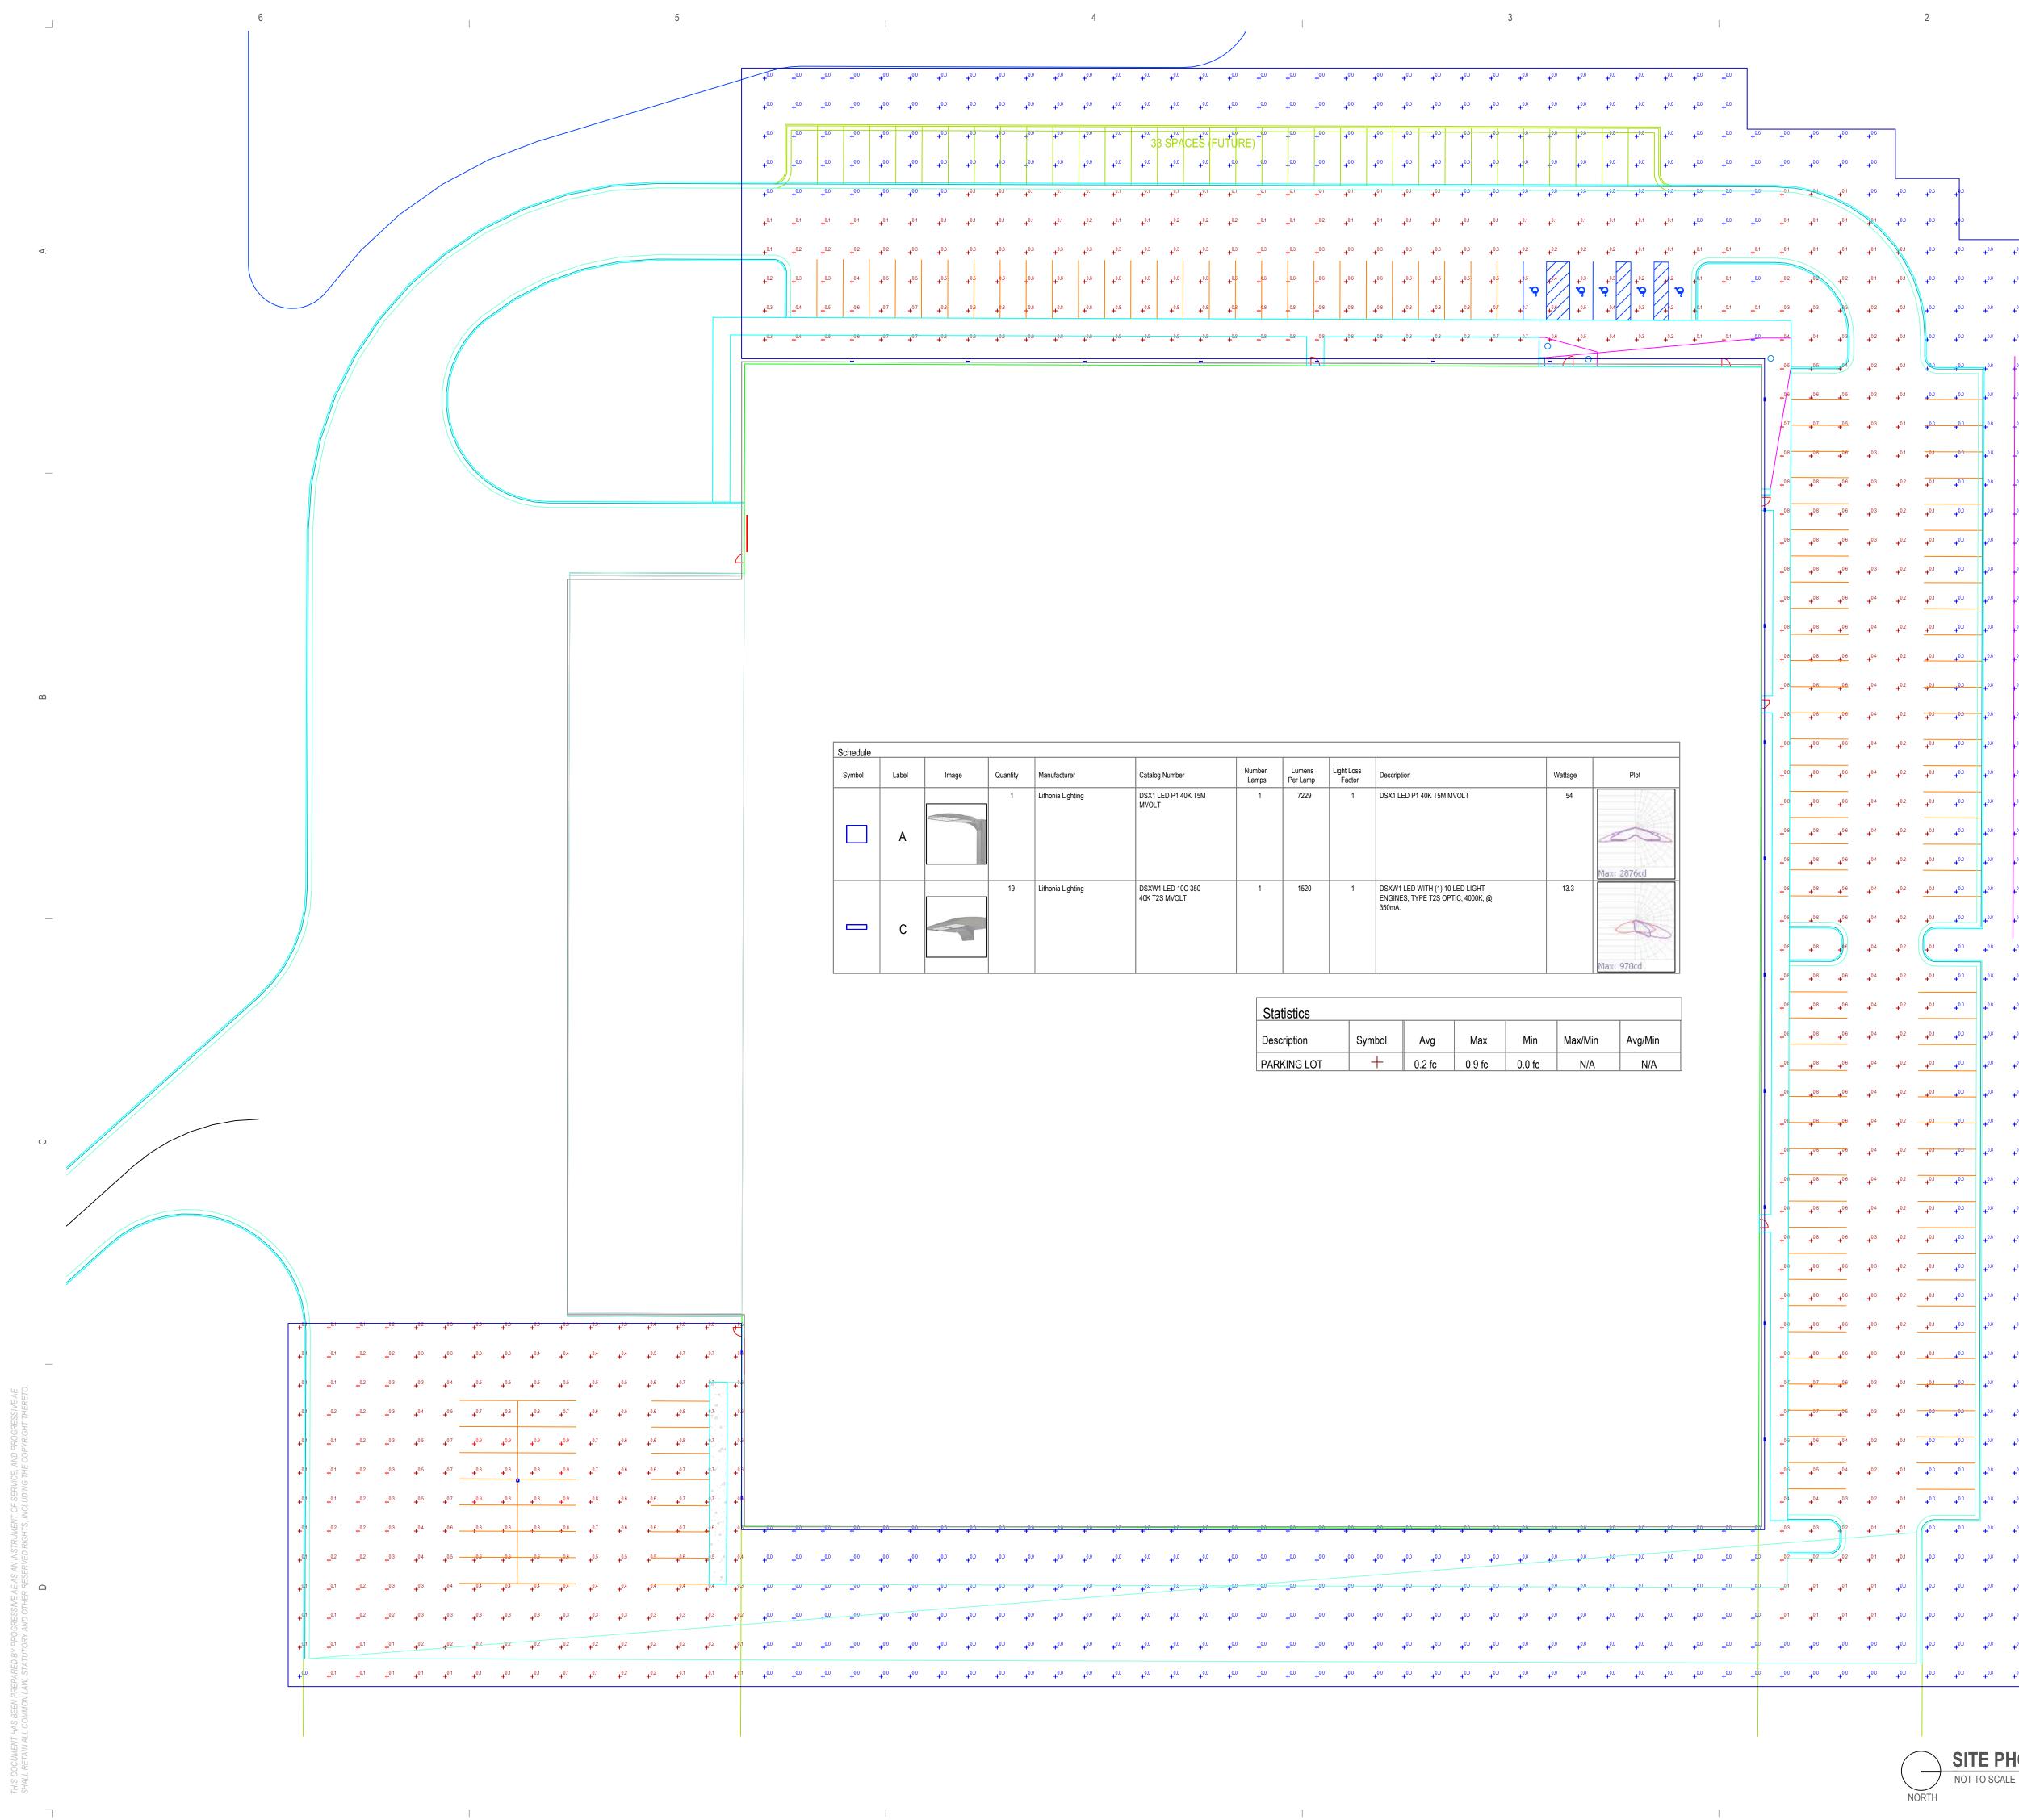


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1811 4 Mile 330 South <sup>-</sup>

PROJECT NUMBER 73680011 PROJECT MANAGER S. TEITSMA PROFESSIONAL B. SIMON DRAWN BY S.VANDYKE CHECKED BY

LANDSCAPE DETAILS L301

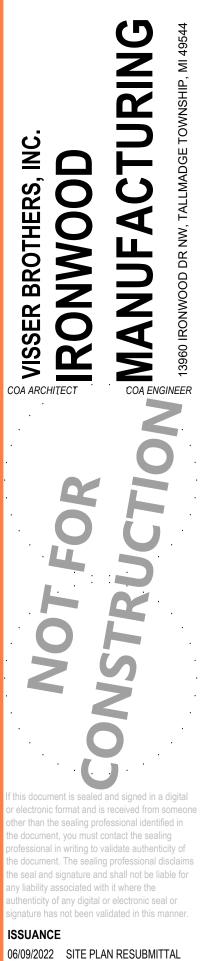


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Image	Quantity	Manufacturer	Catalog Number	Lamps	Per Lamp	Factor	Description	Wattage	Plot
	1	Lithonia Lighting	DSX1 LED P1 40K T5M MVOLT	1	7229	1	DSX1 LED P1 40K T5M MVOLT	54	
									Max: 2876cd
	19	Lithonia Lighting	DSXW1 LED 10C 350 40K T2S MVOLT	1	1520		DSXW1 LED WITH (1) 10 LED LIGHT ENGINES, TYPE T2S OPTIC, 4000K, @ 350mA.	13.3	0
									Max: 970cd

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Statistics						
Description	Symbol	Avg	Max	Min	Max/Min	Avg/Min
PARKING LOT	+	0.2 fc	0.9 fc	0.0 fc	N/A	N/A

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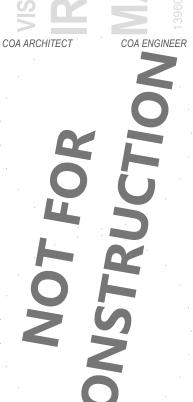


PROFESSIONAL D. HERSCHER DRAWN BY K. WOOD CHECKED BY D. HERSCHER

PROJECT NUMBER 73680011 PROJECT MANAGER

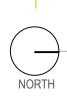ISSUANCE 06/09/2022 SITE PLAN RESUBMITTAL


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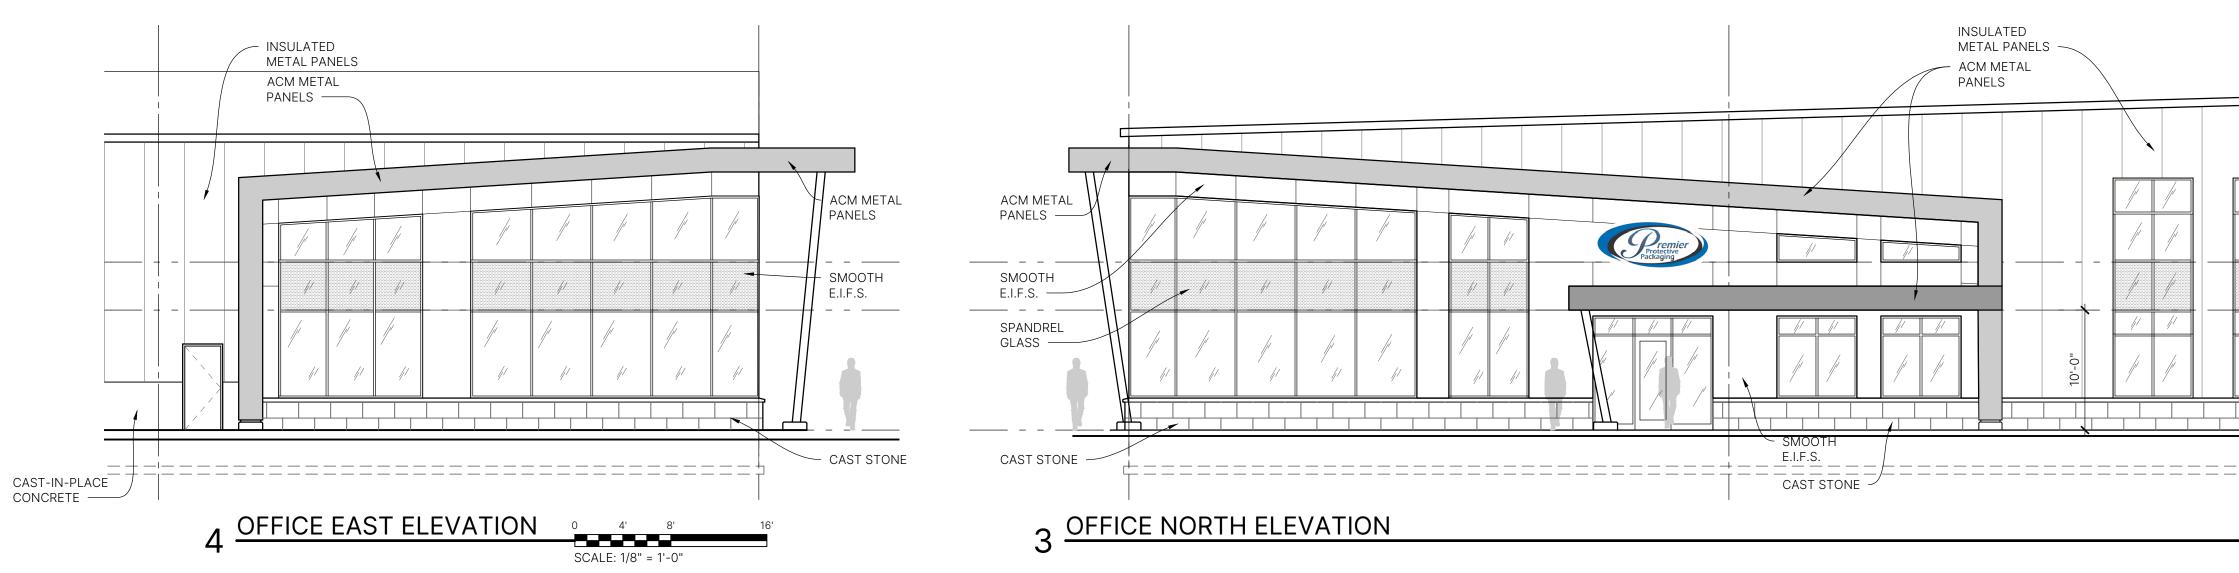



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 $(\mathbf{1})$ STORAGE & TOILET ROOMS - LAYOUT T.B.D.  $\begin{pmatrix} 3 \\ A5 \end{pmatrix}$  $\searrow$ OVERALL BUILDING PLAN 







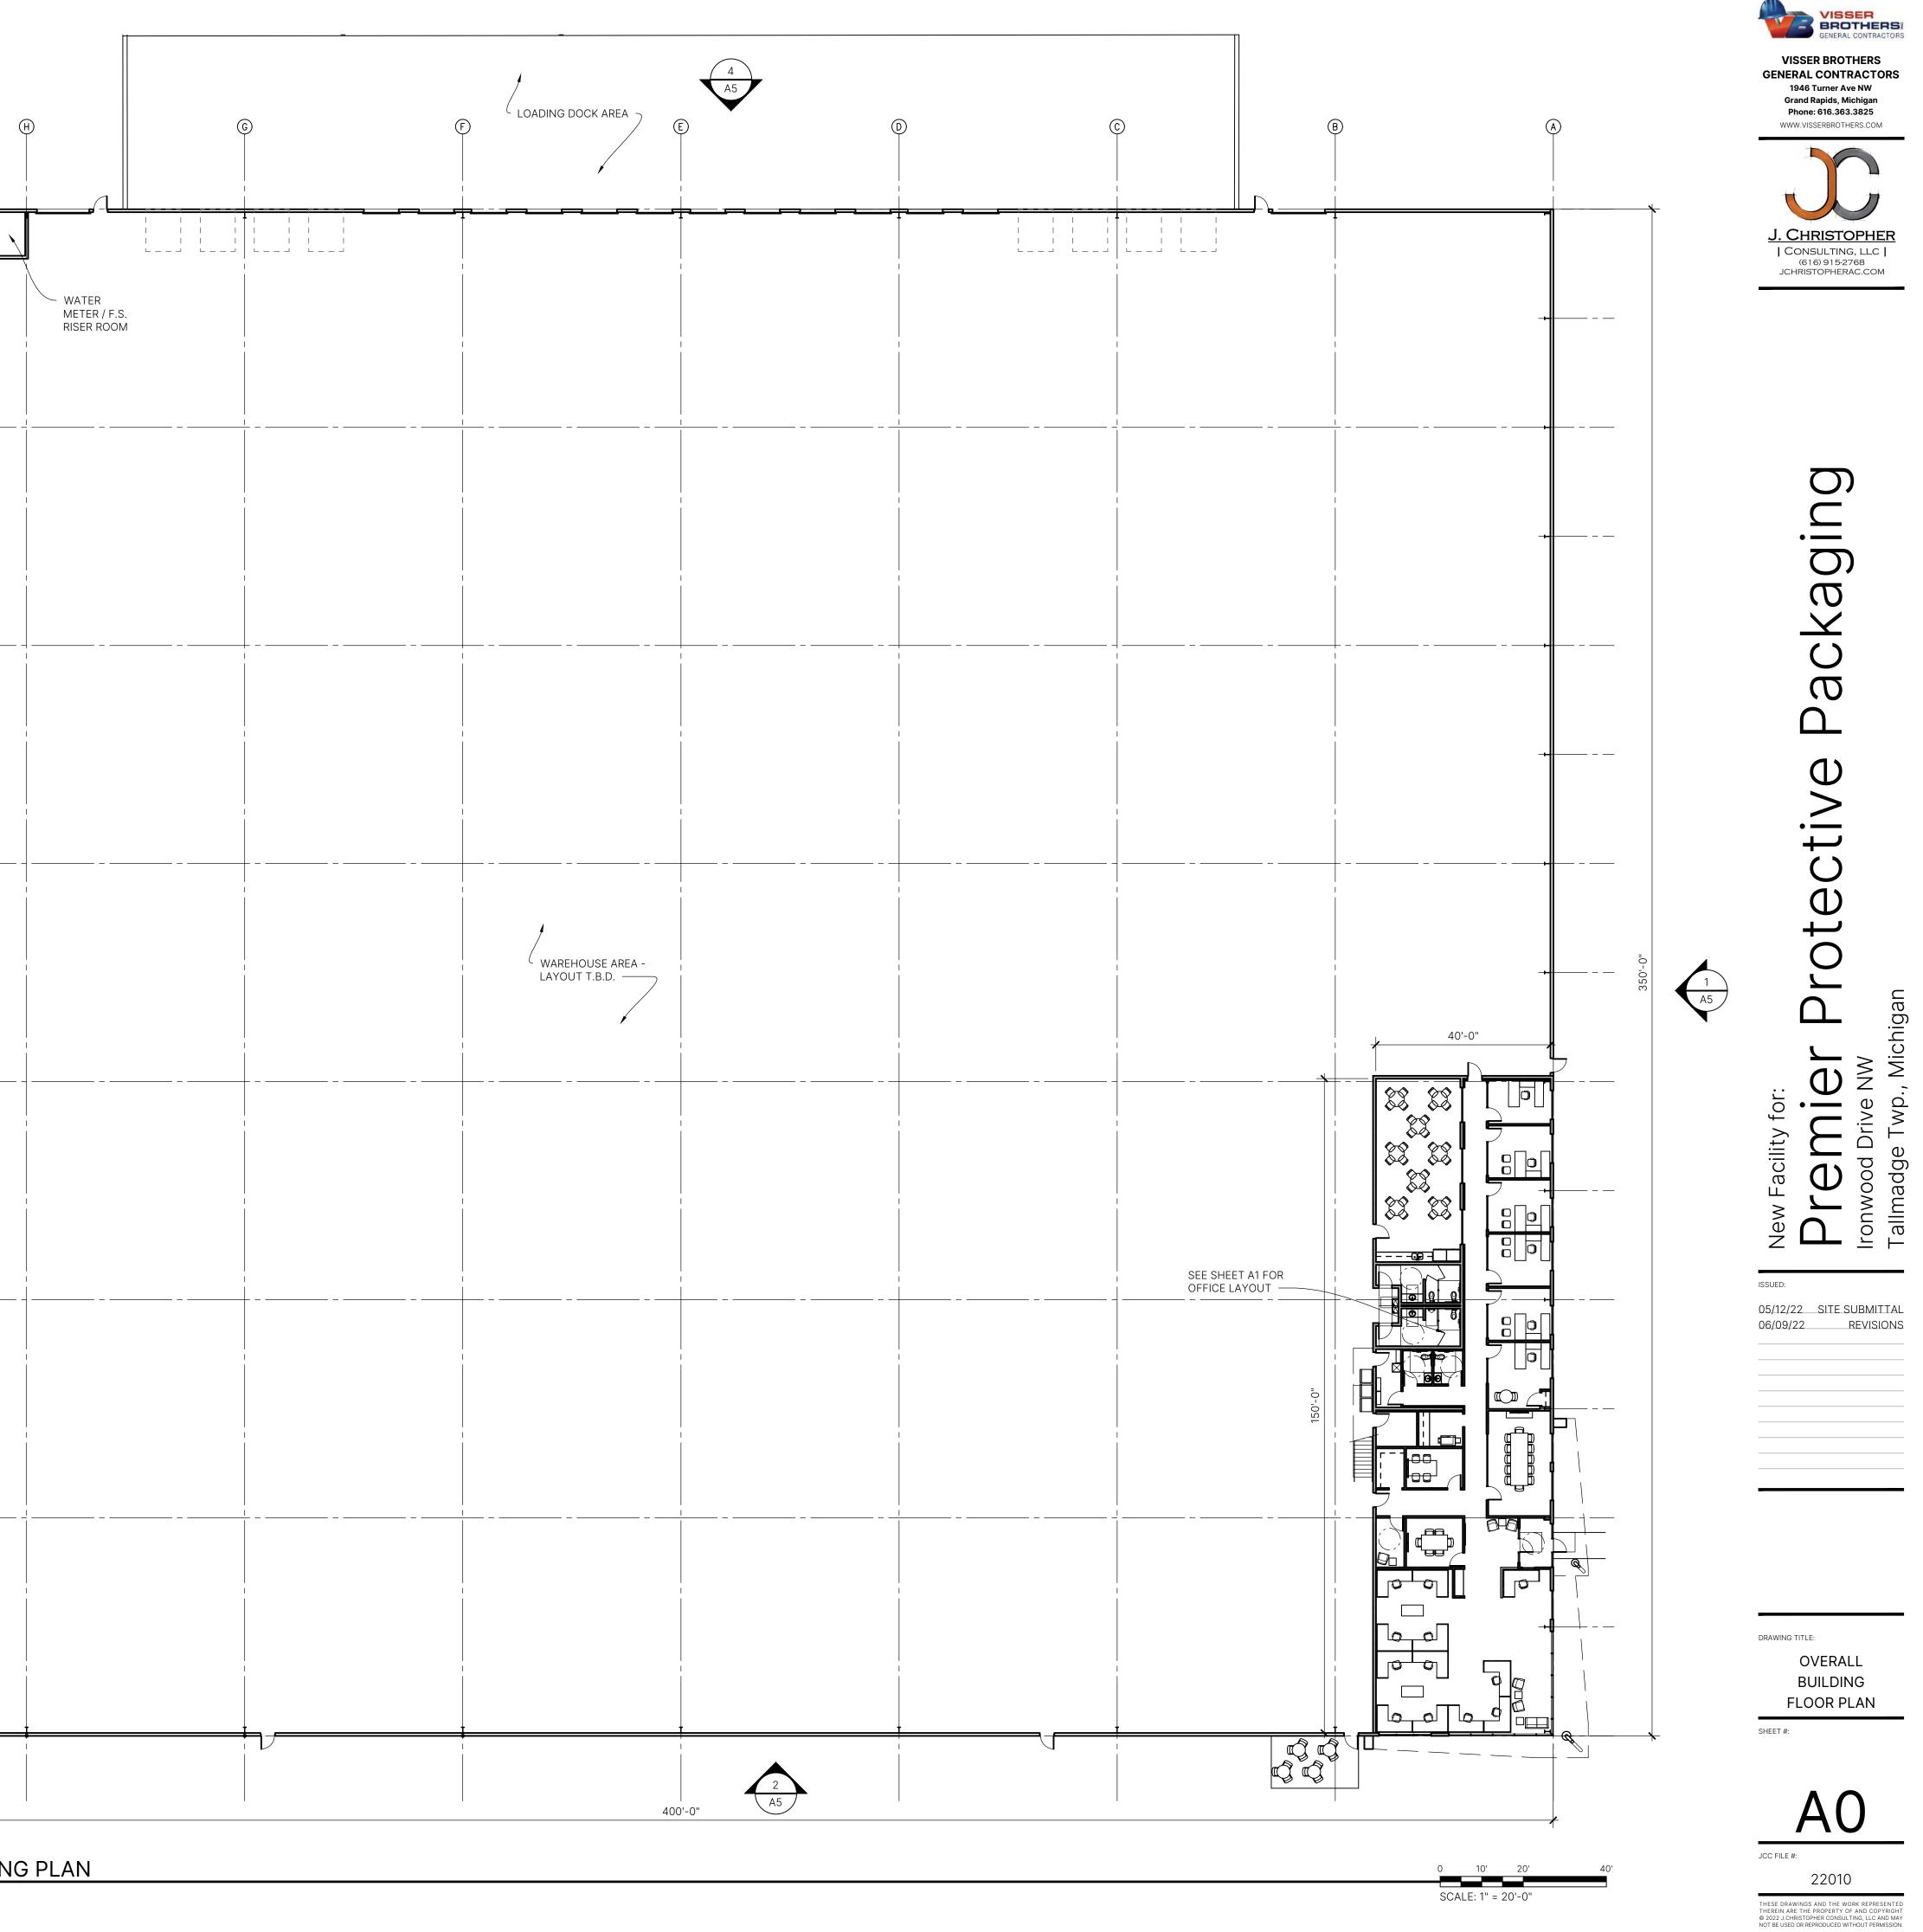



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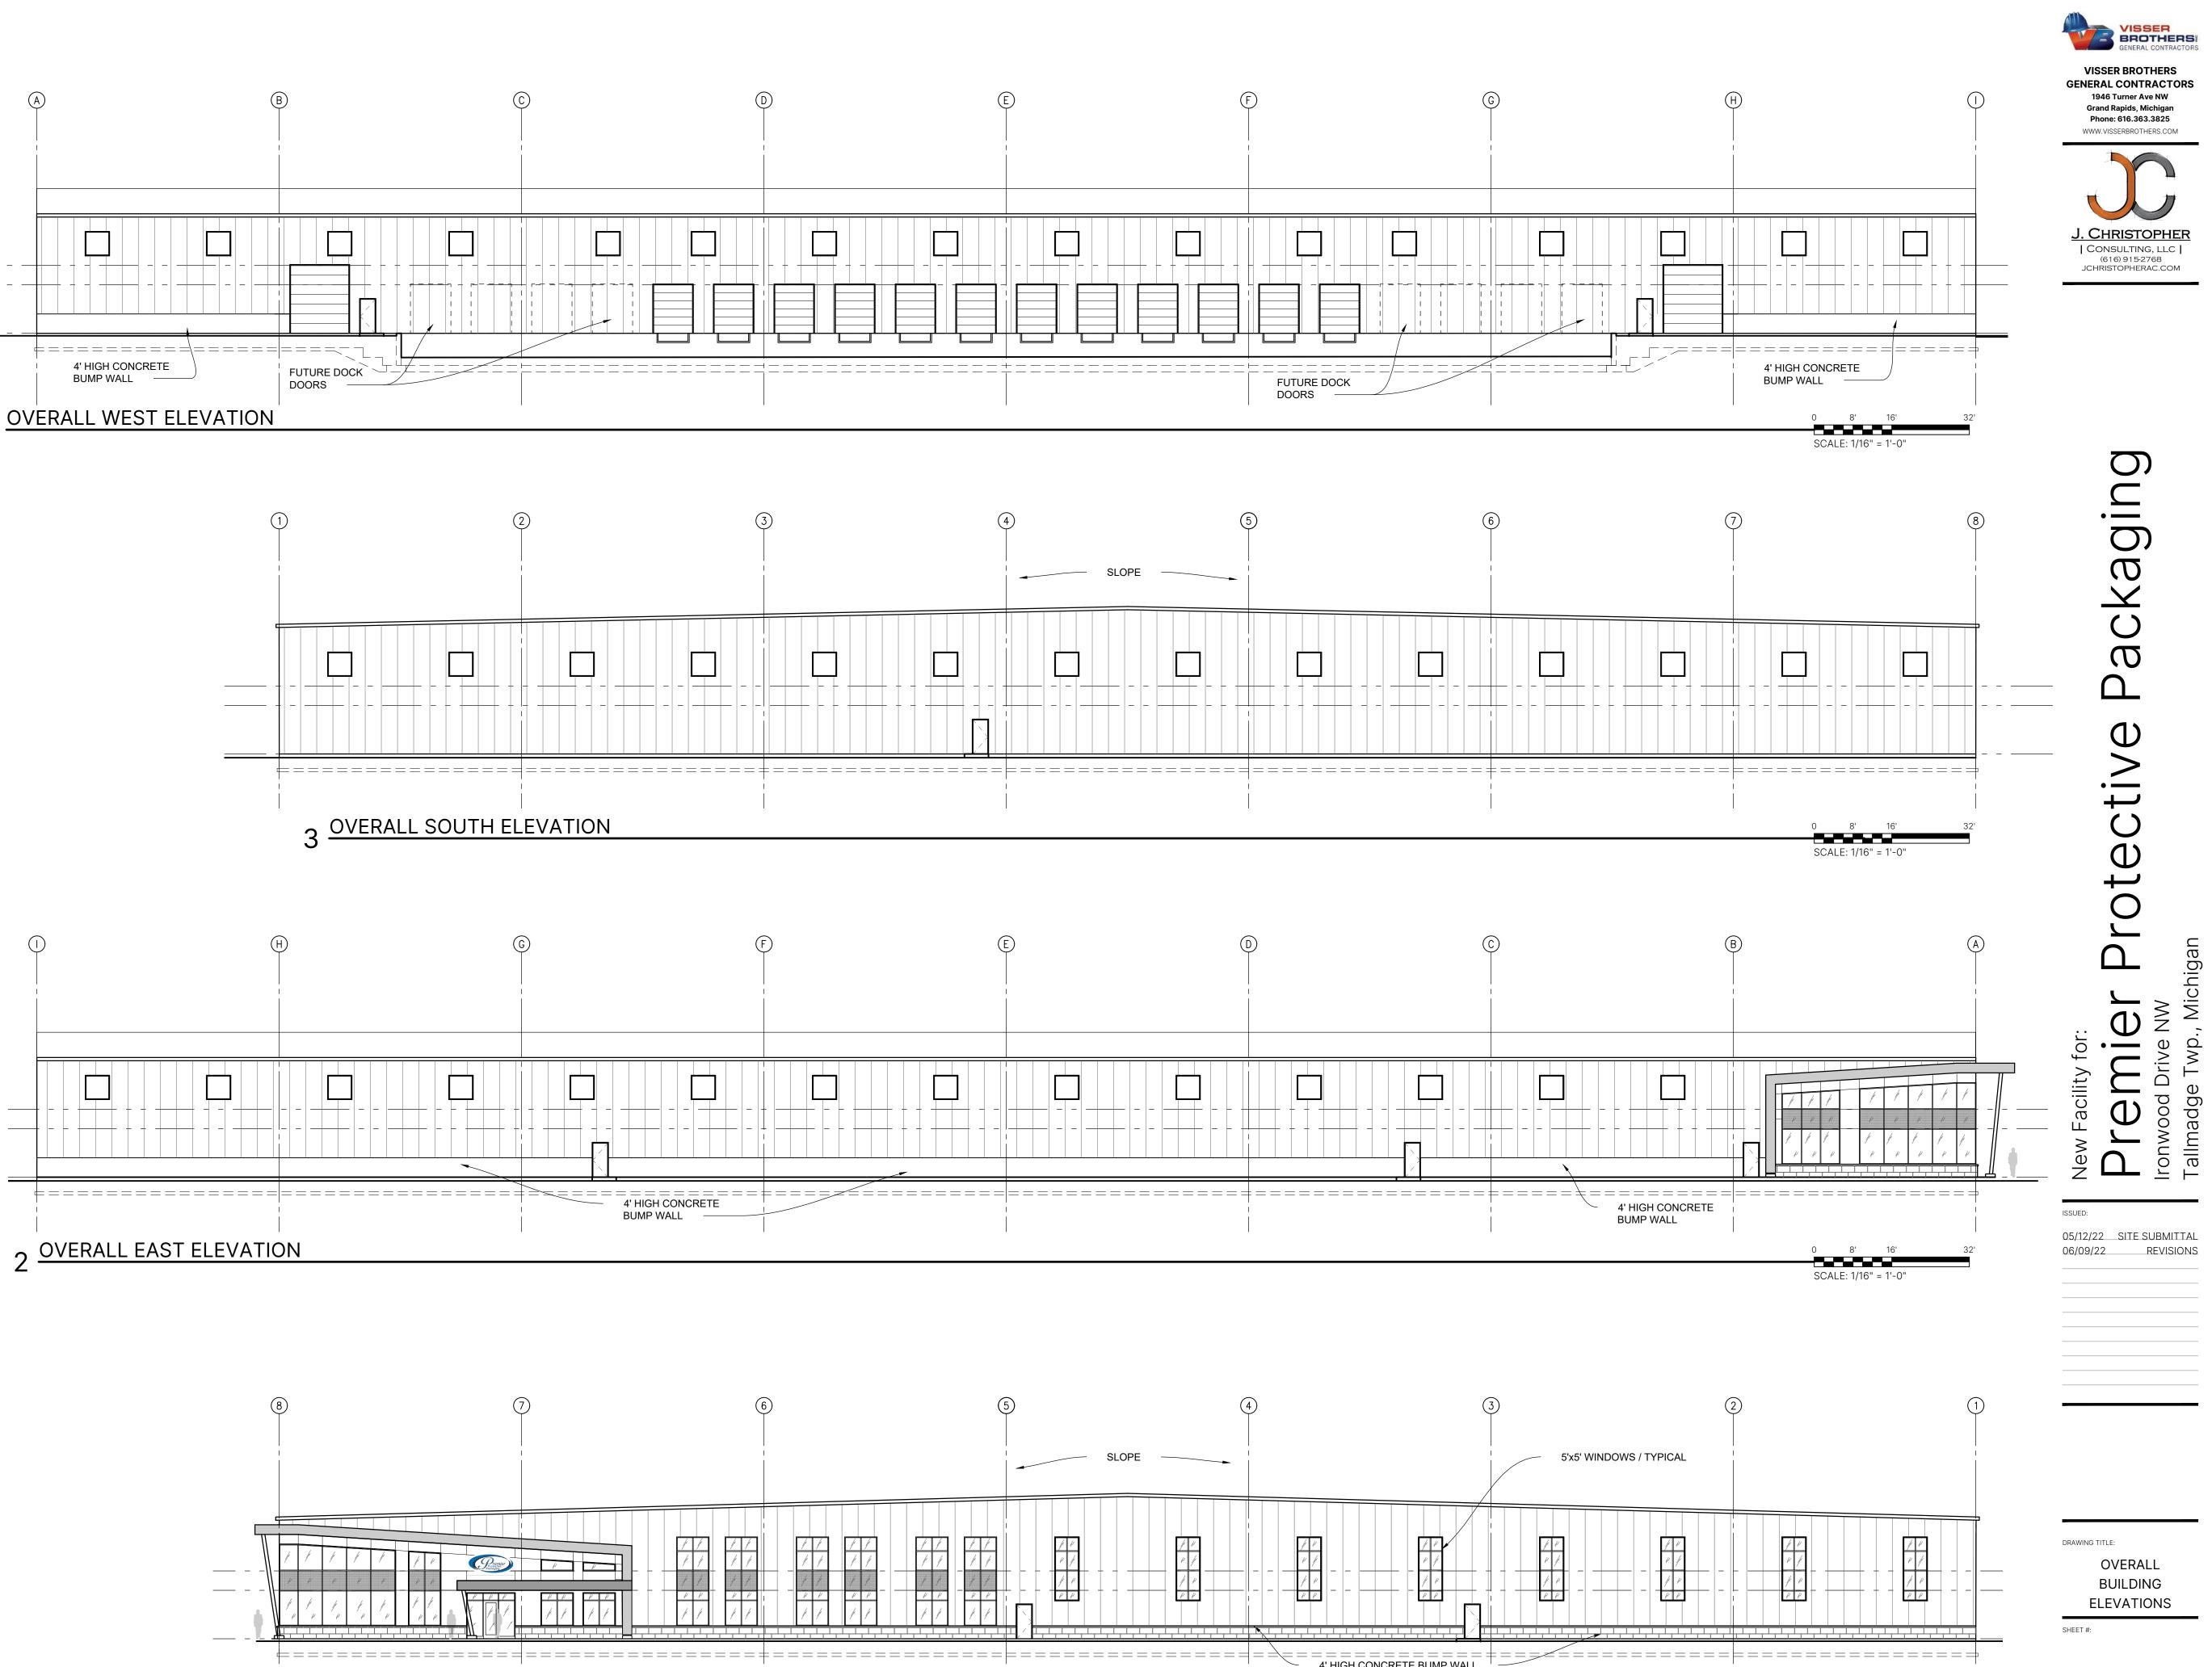
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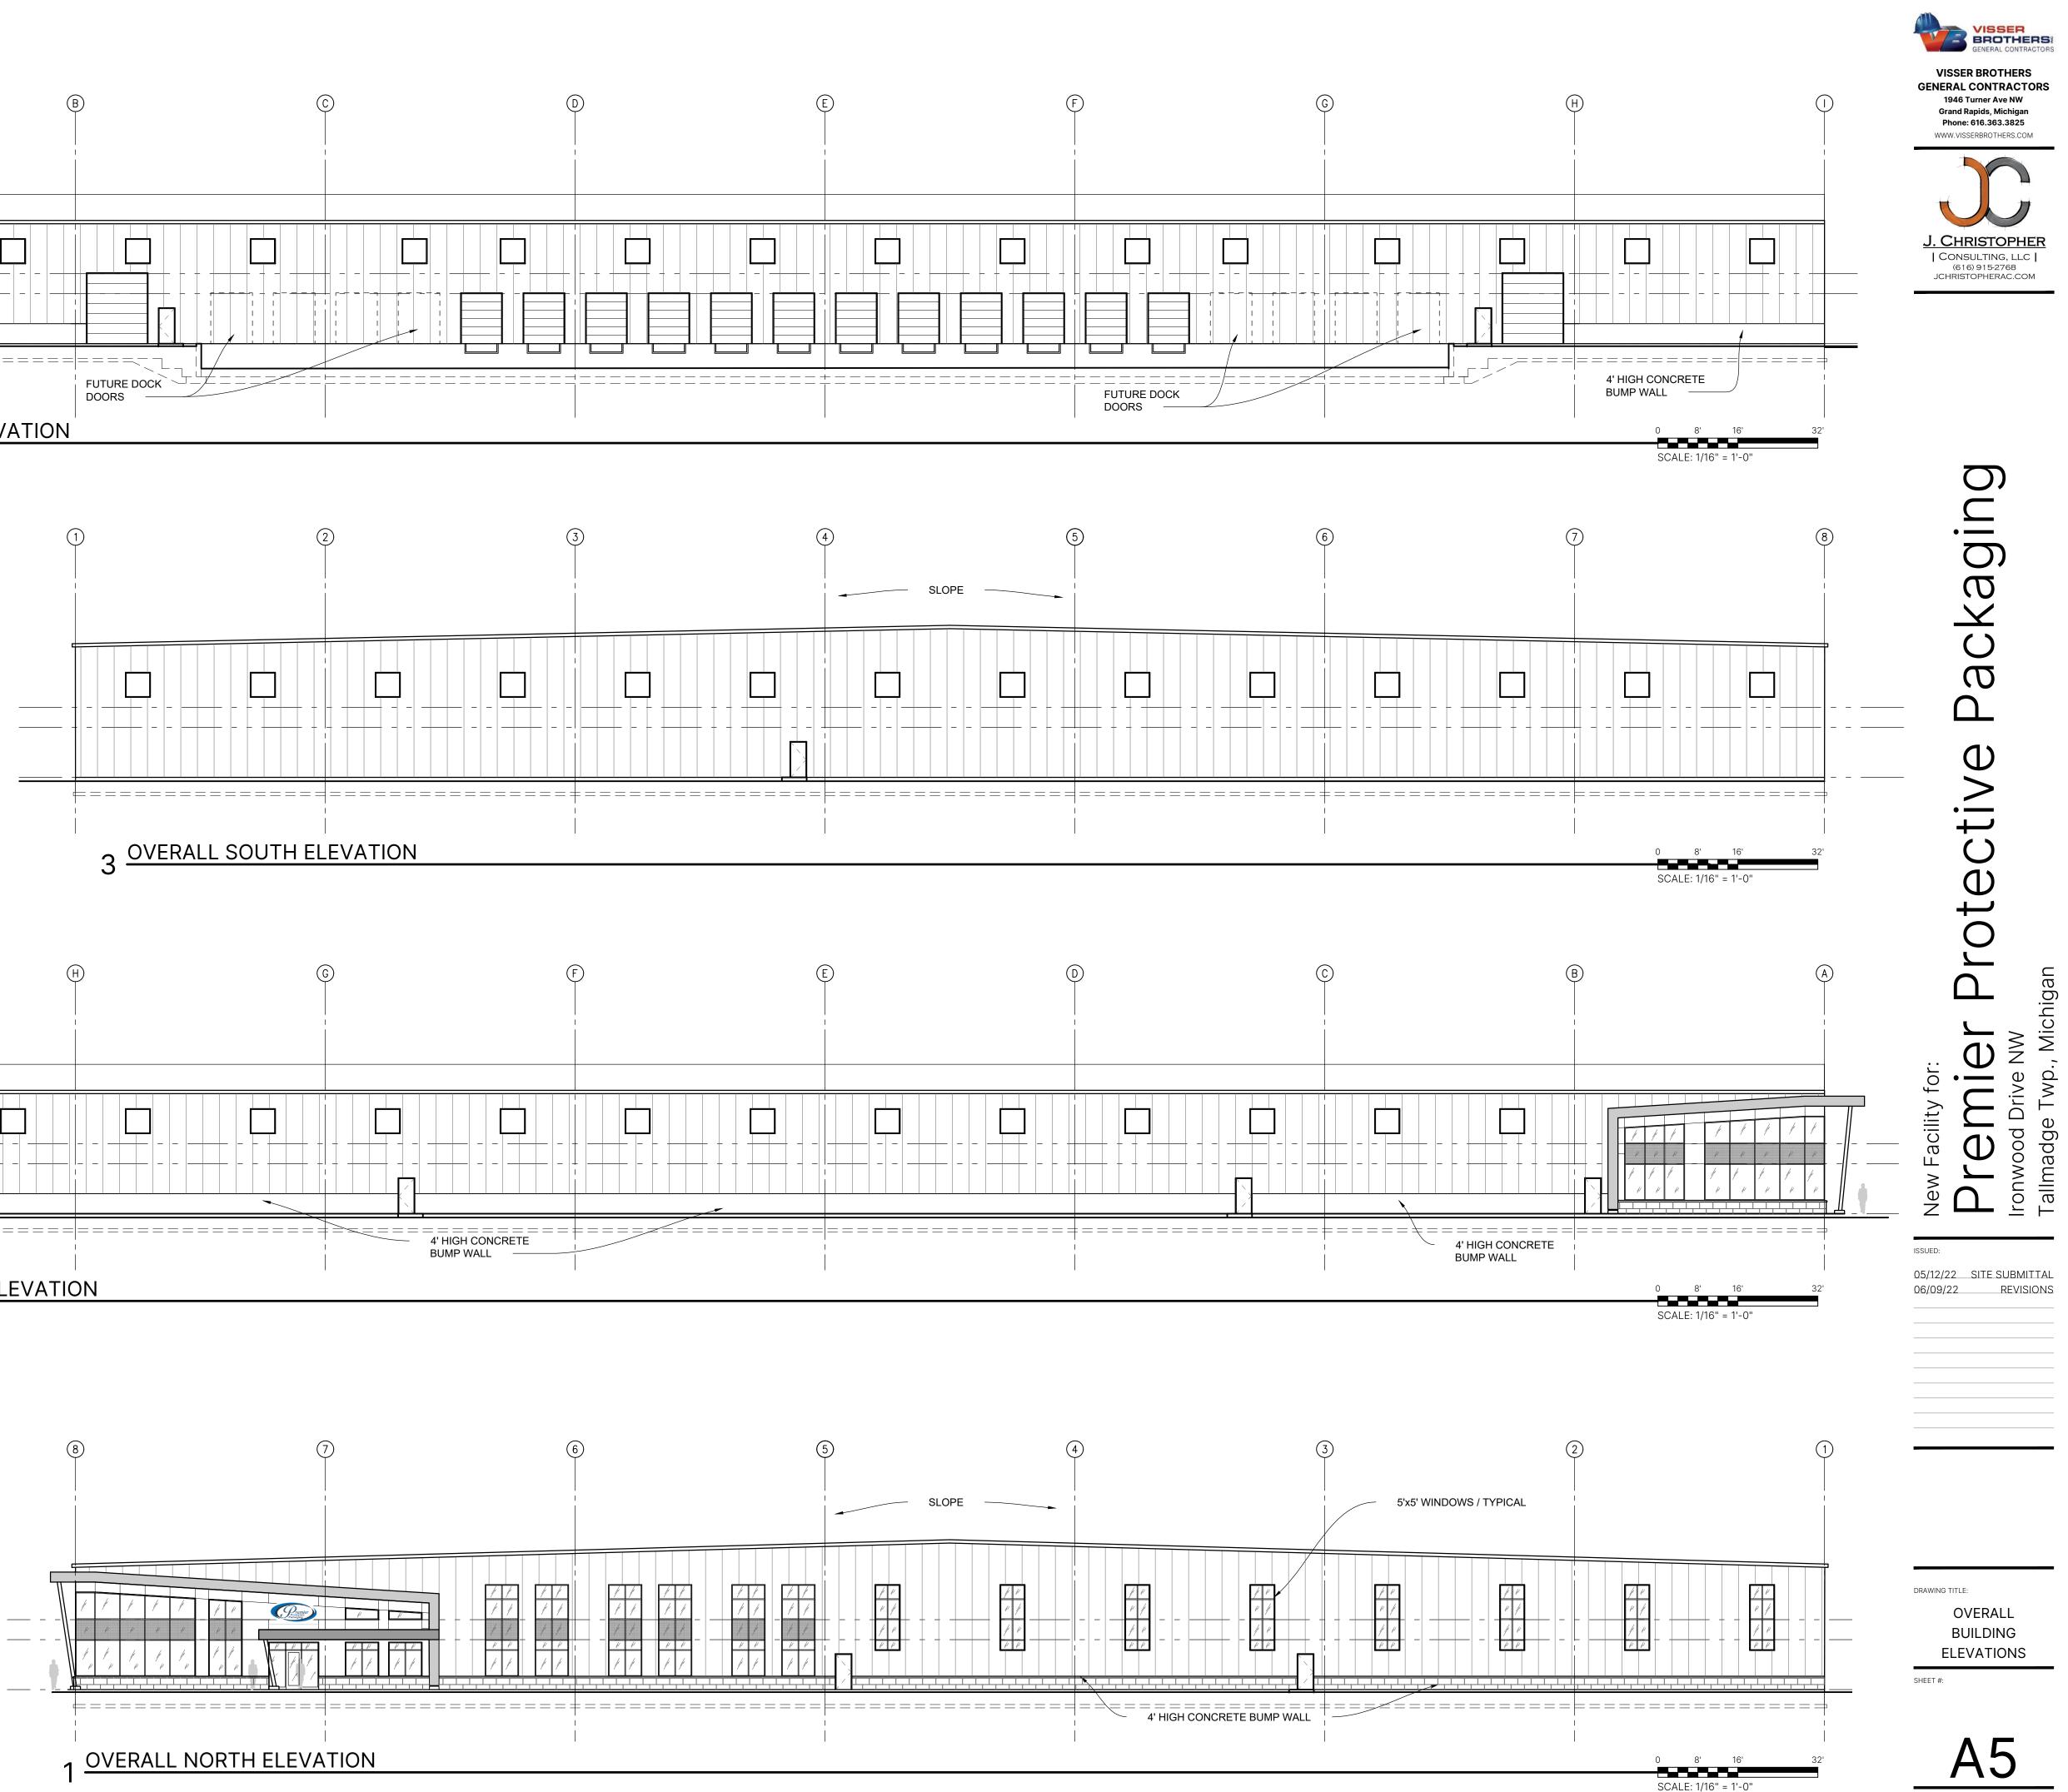


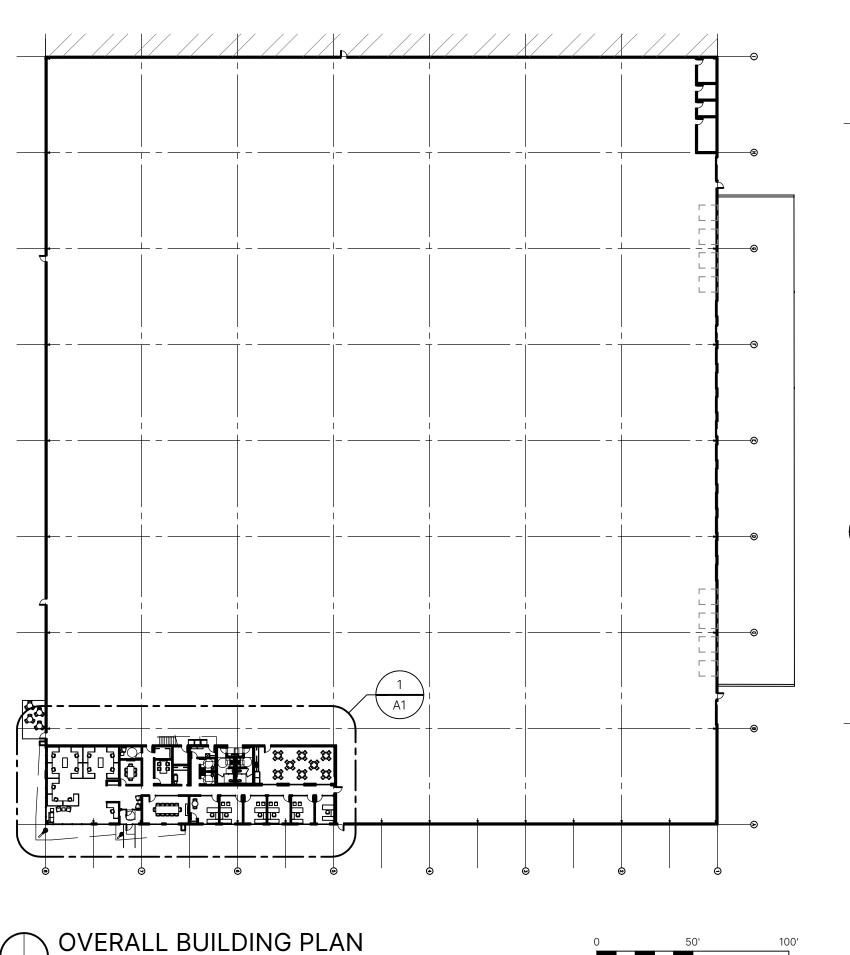


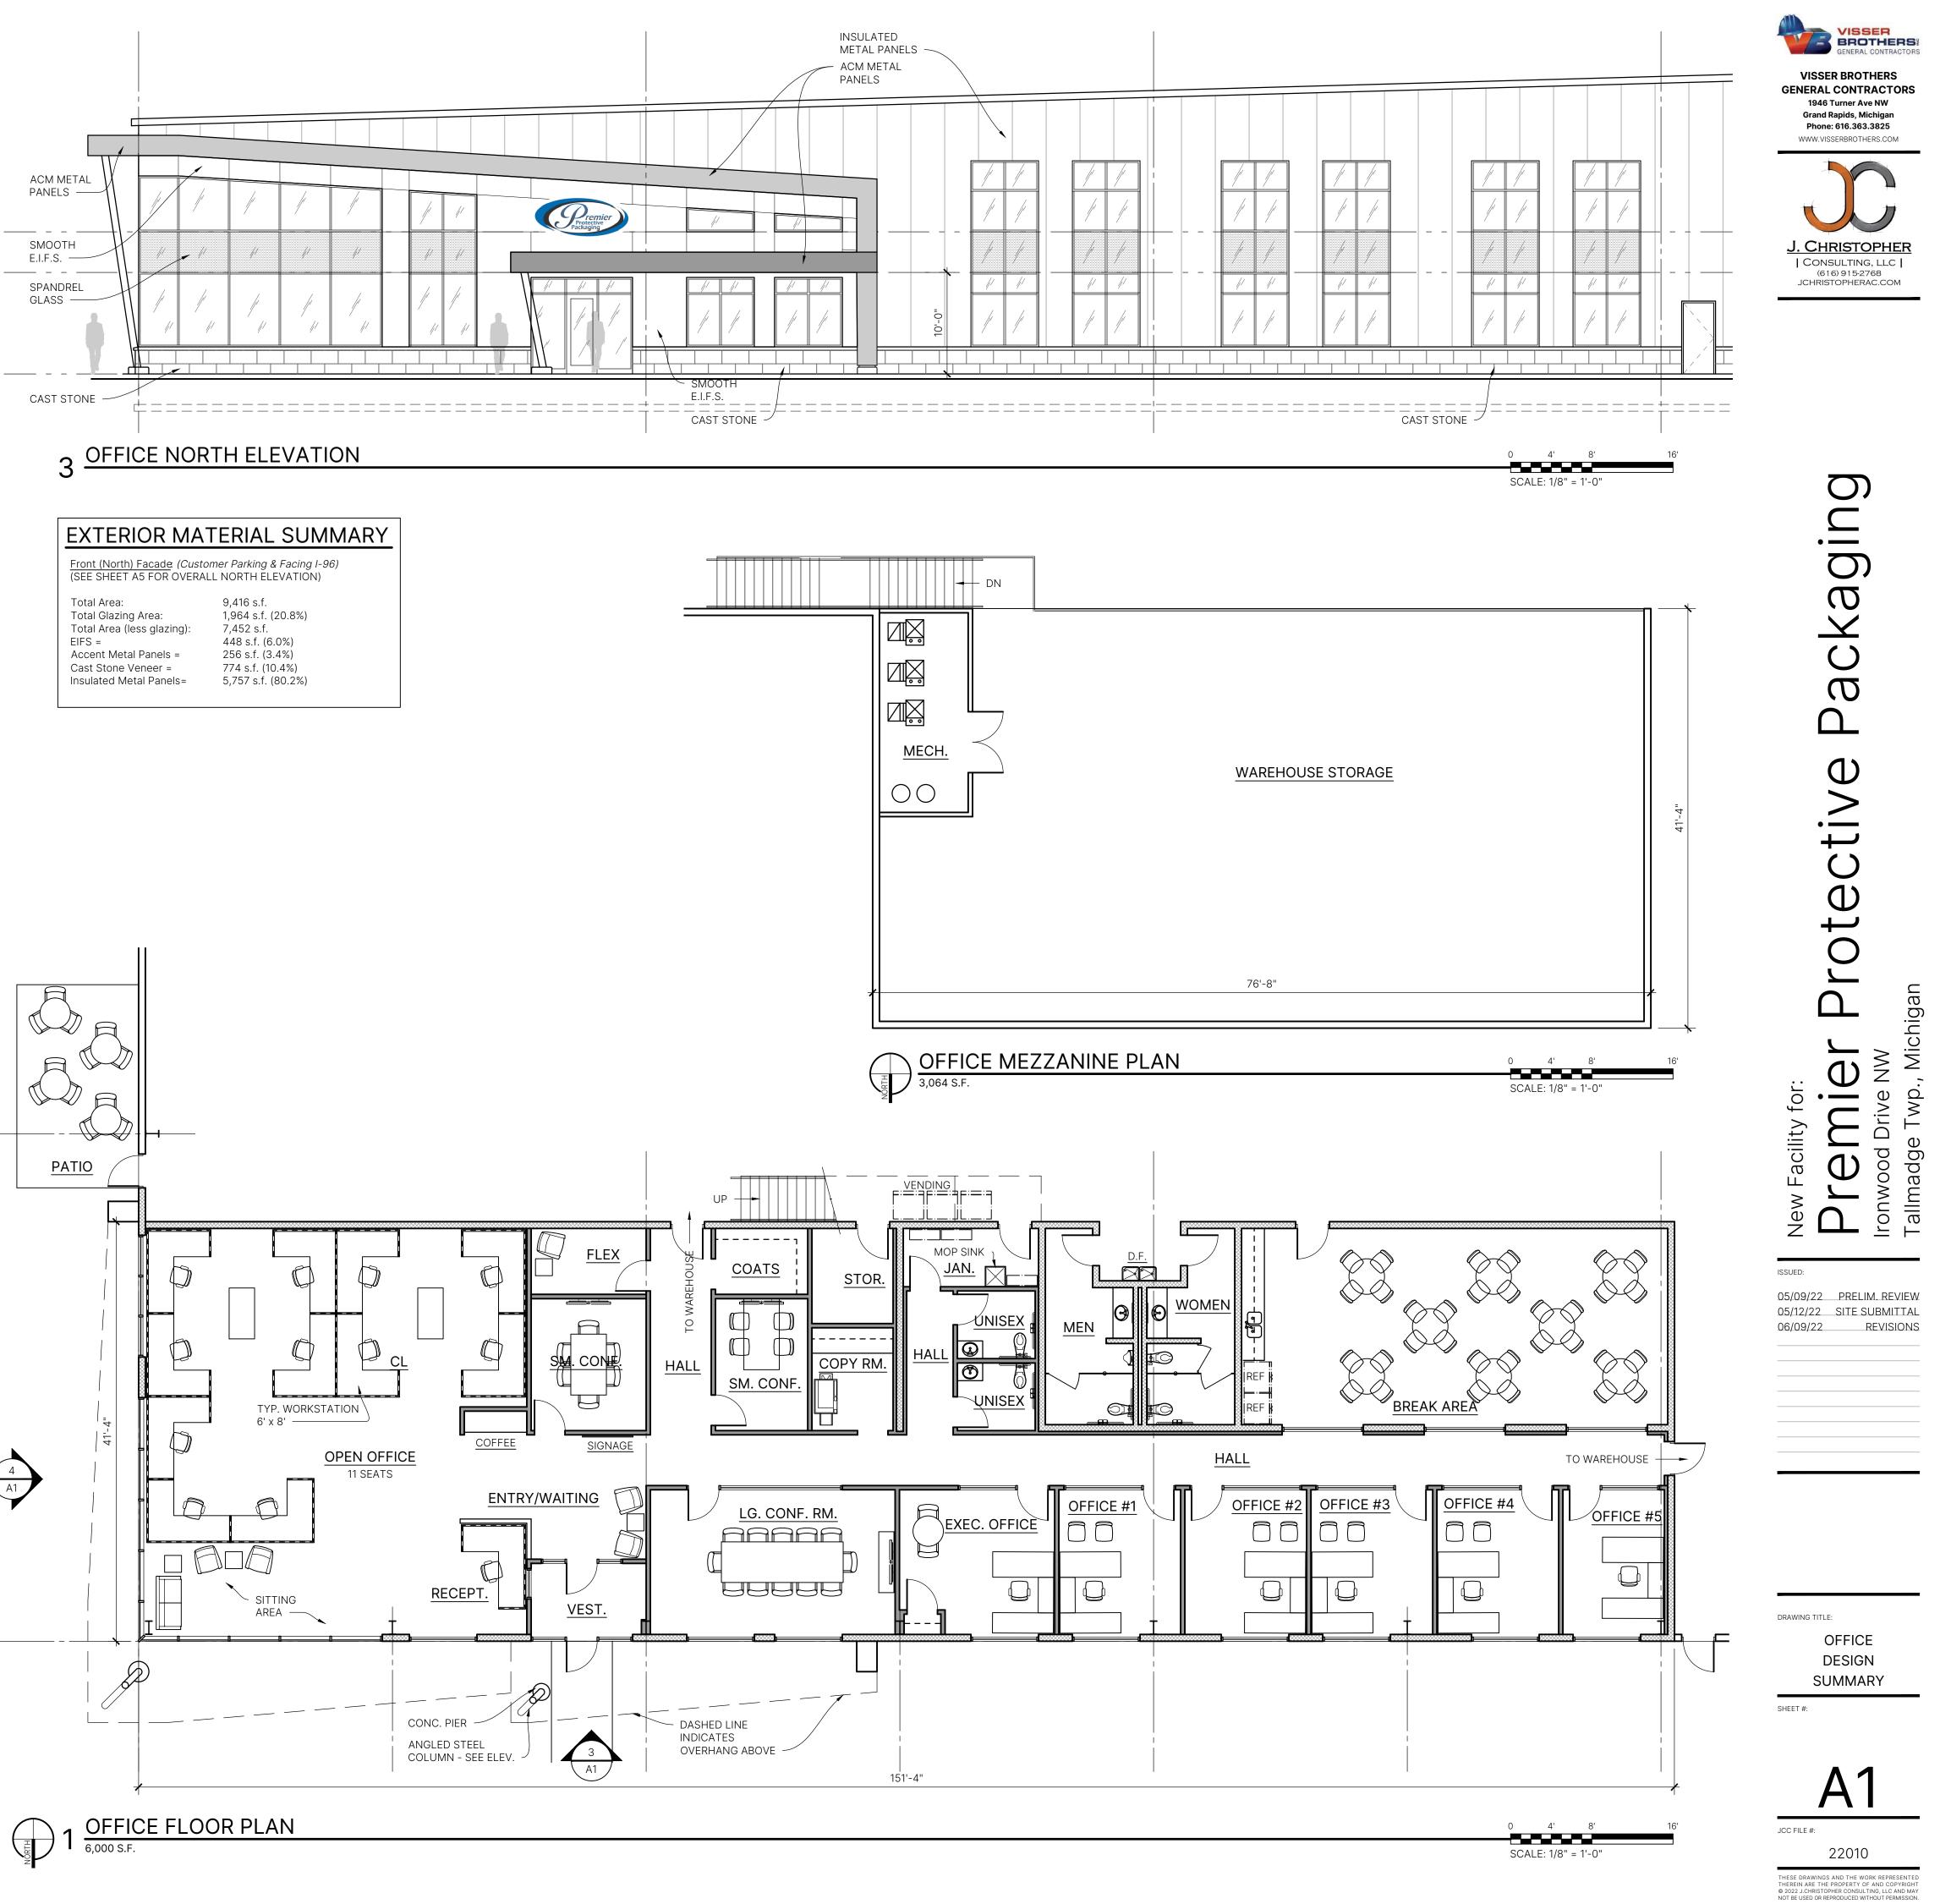

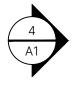

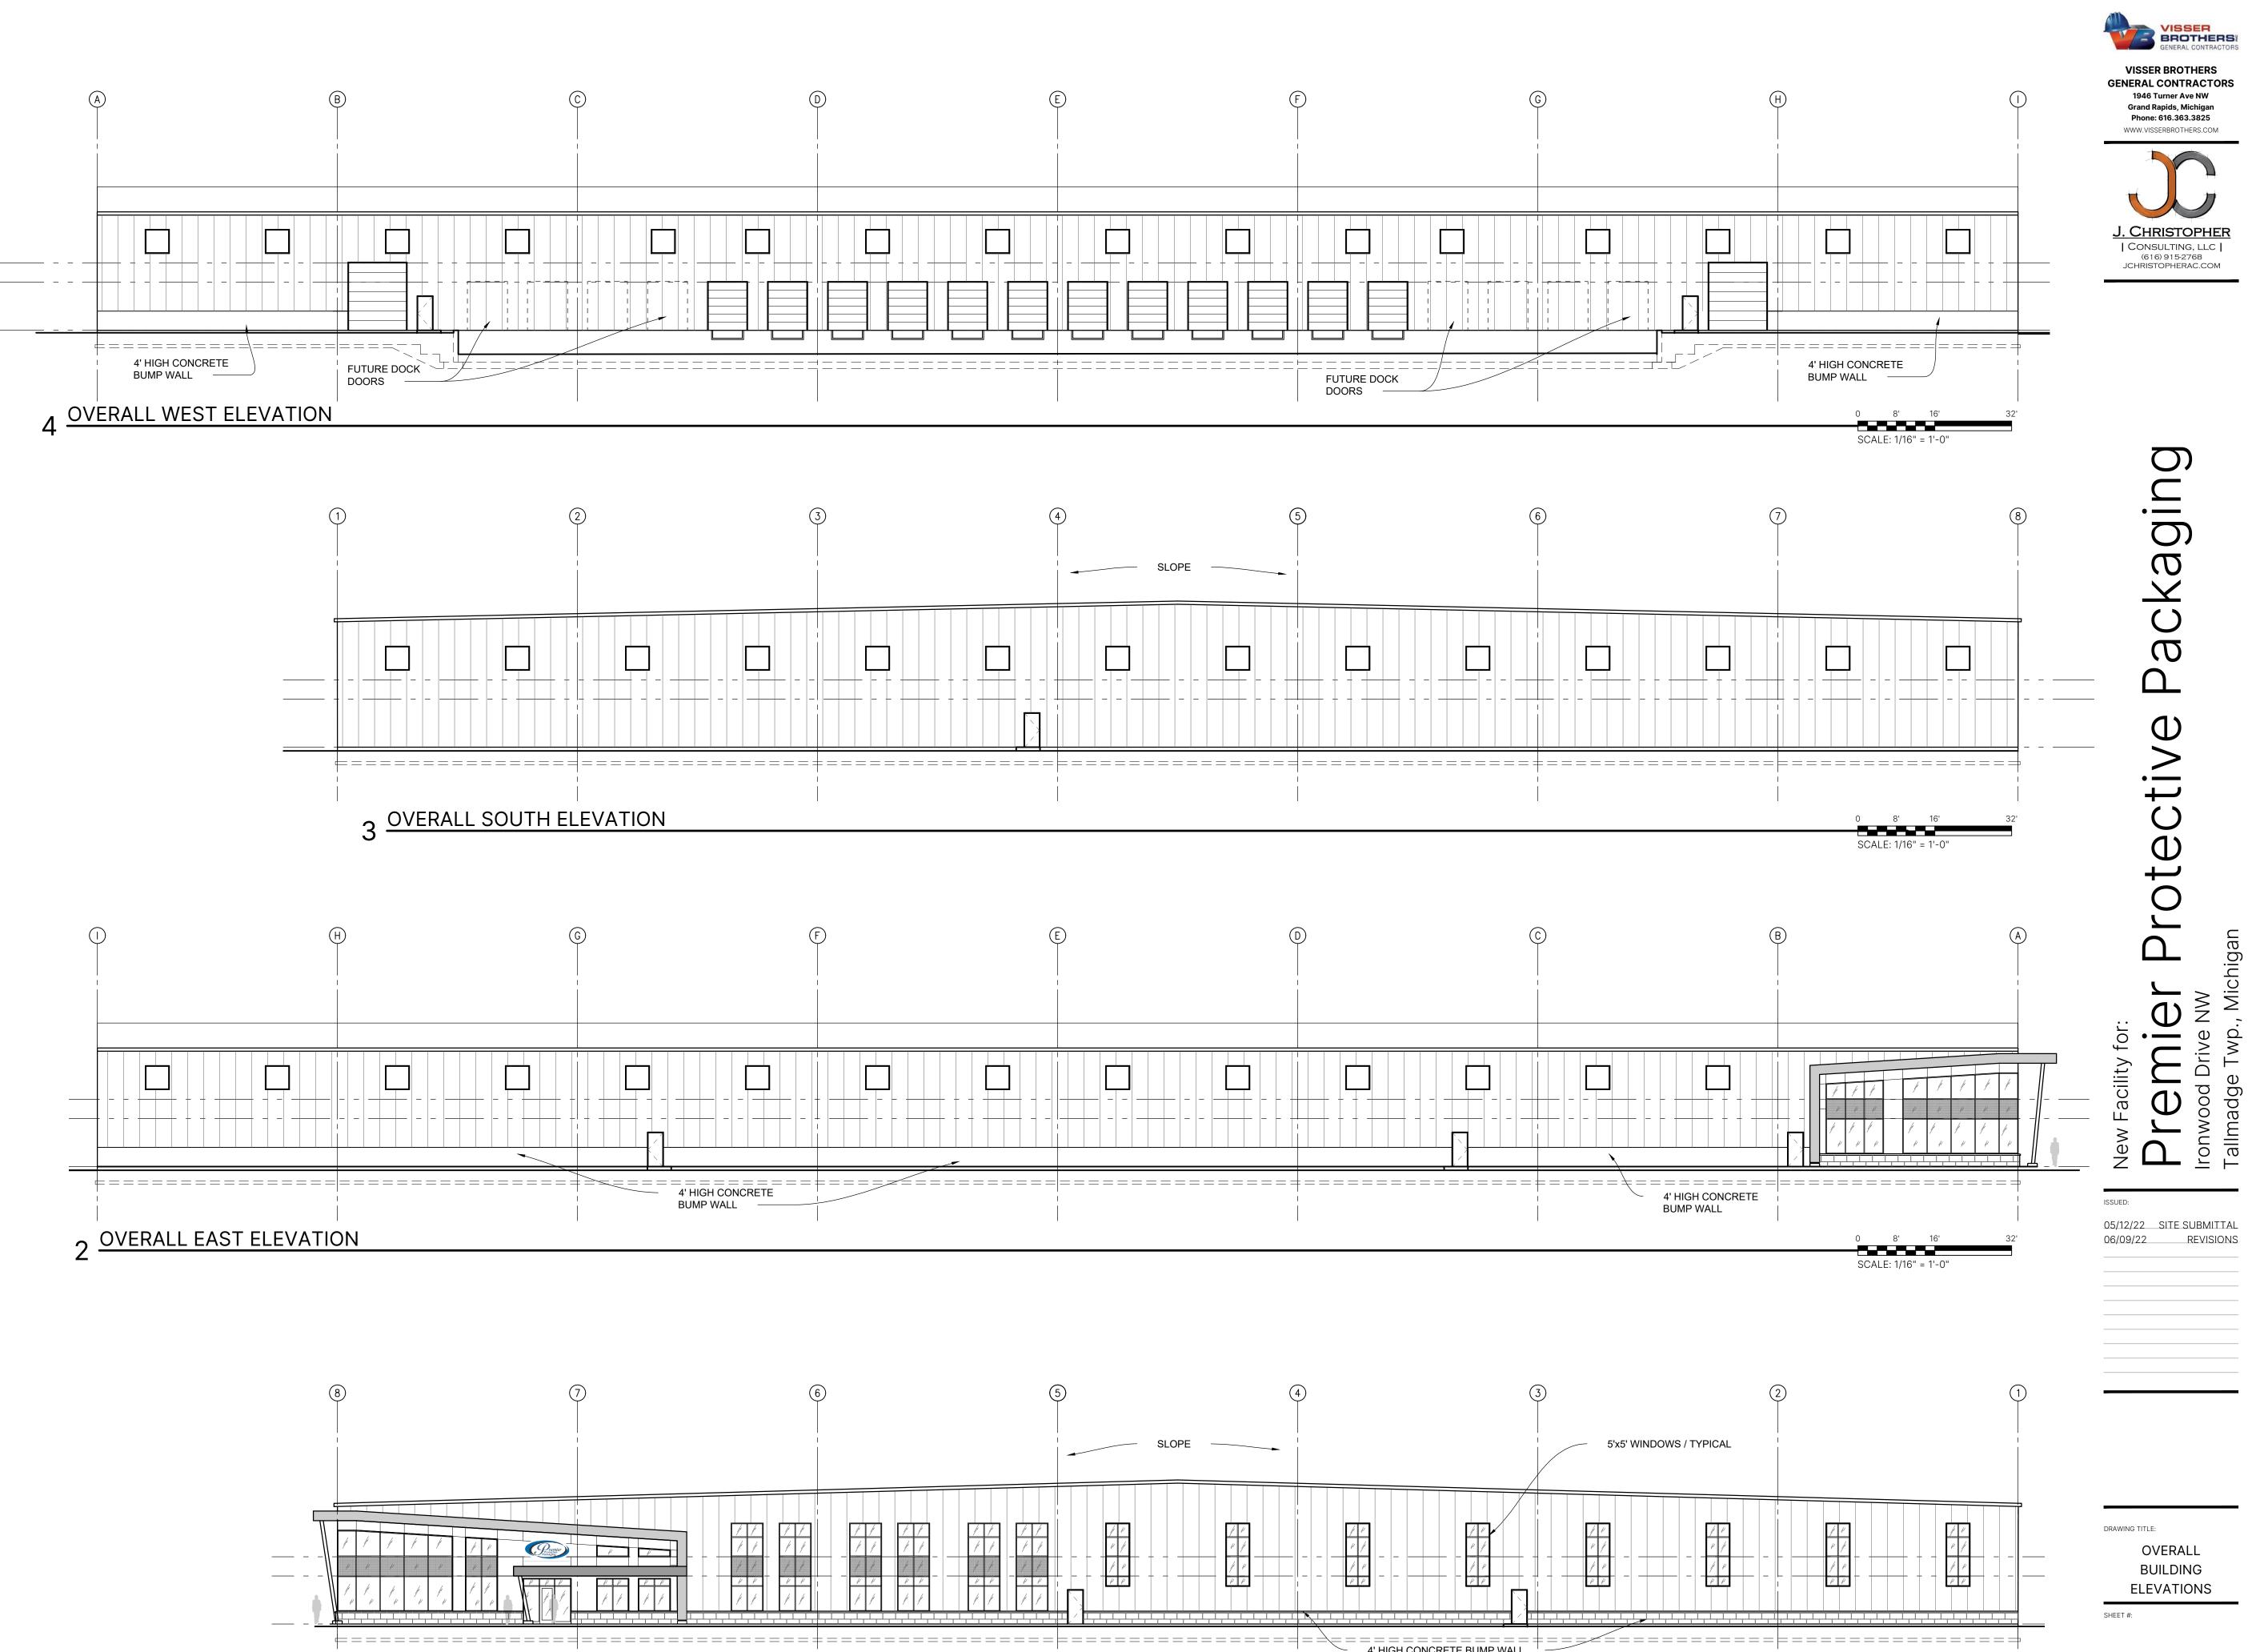

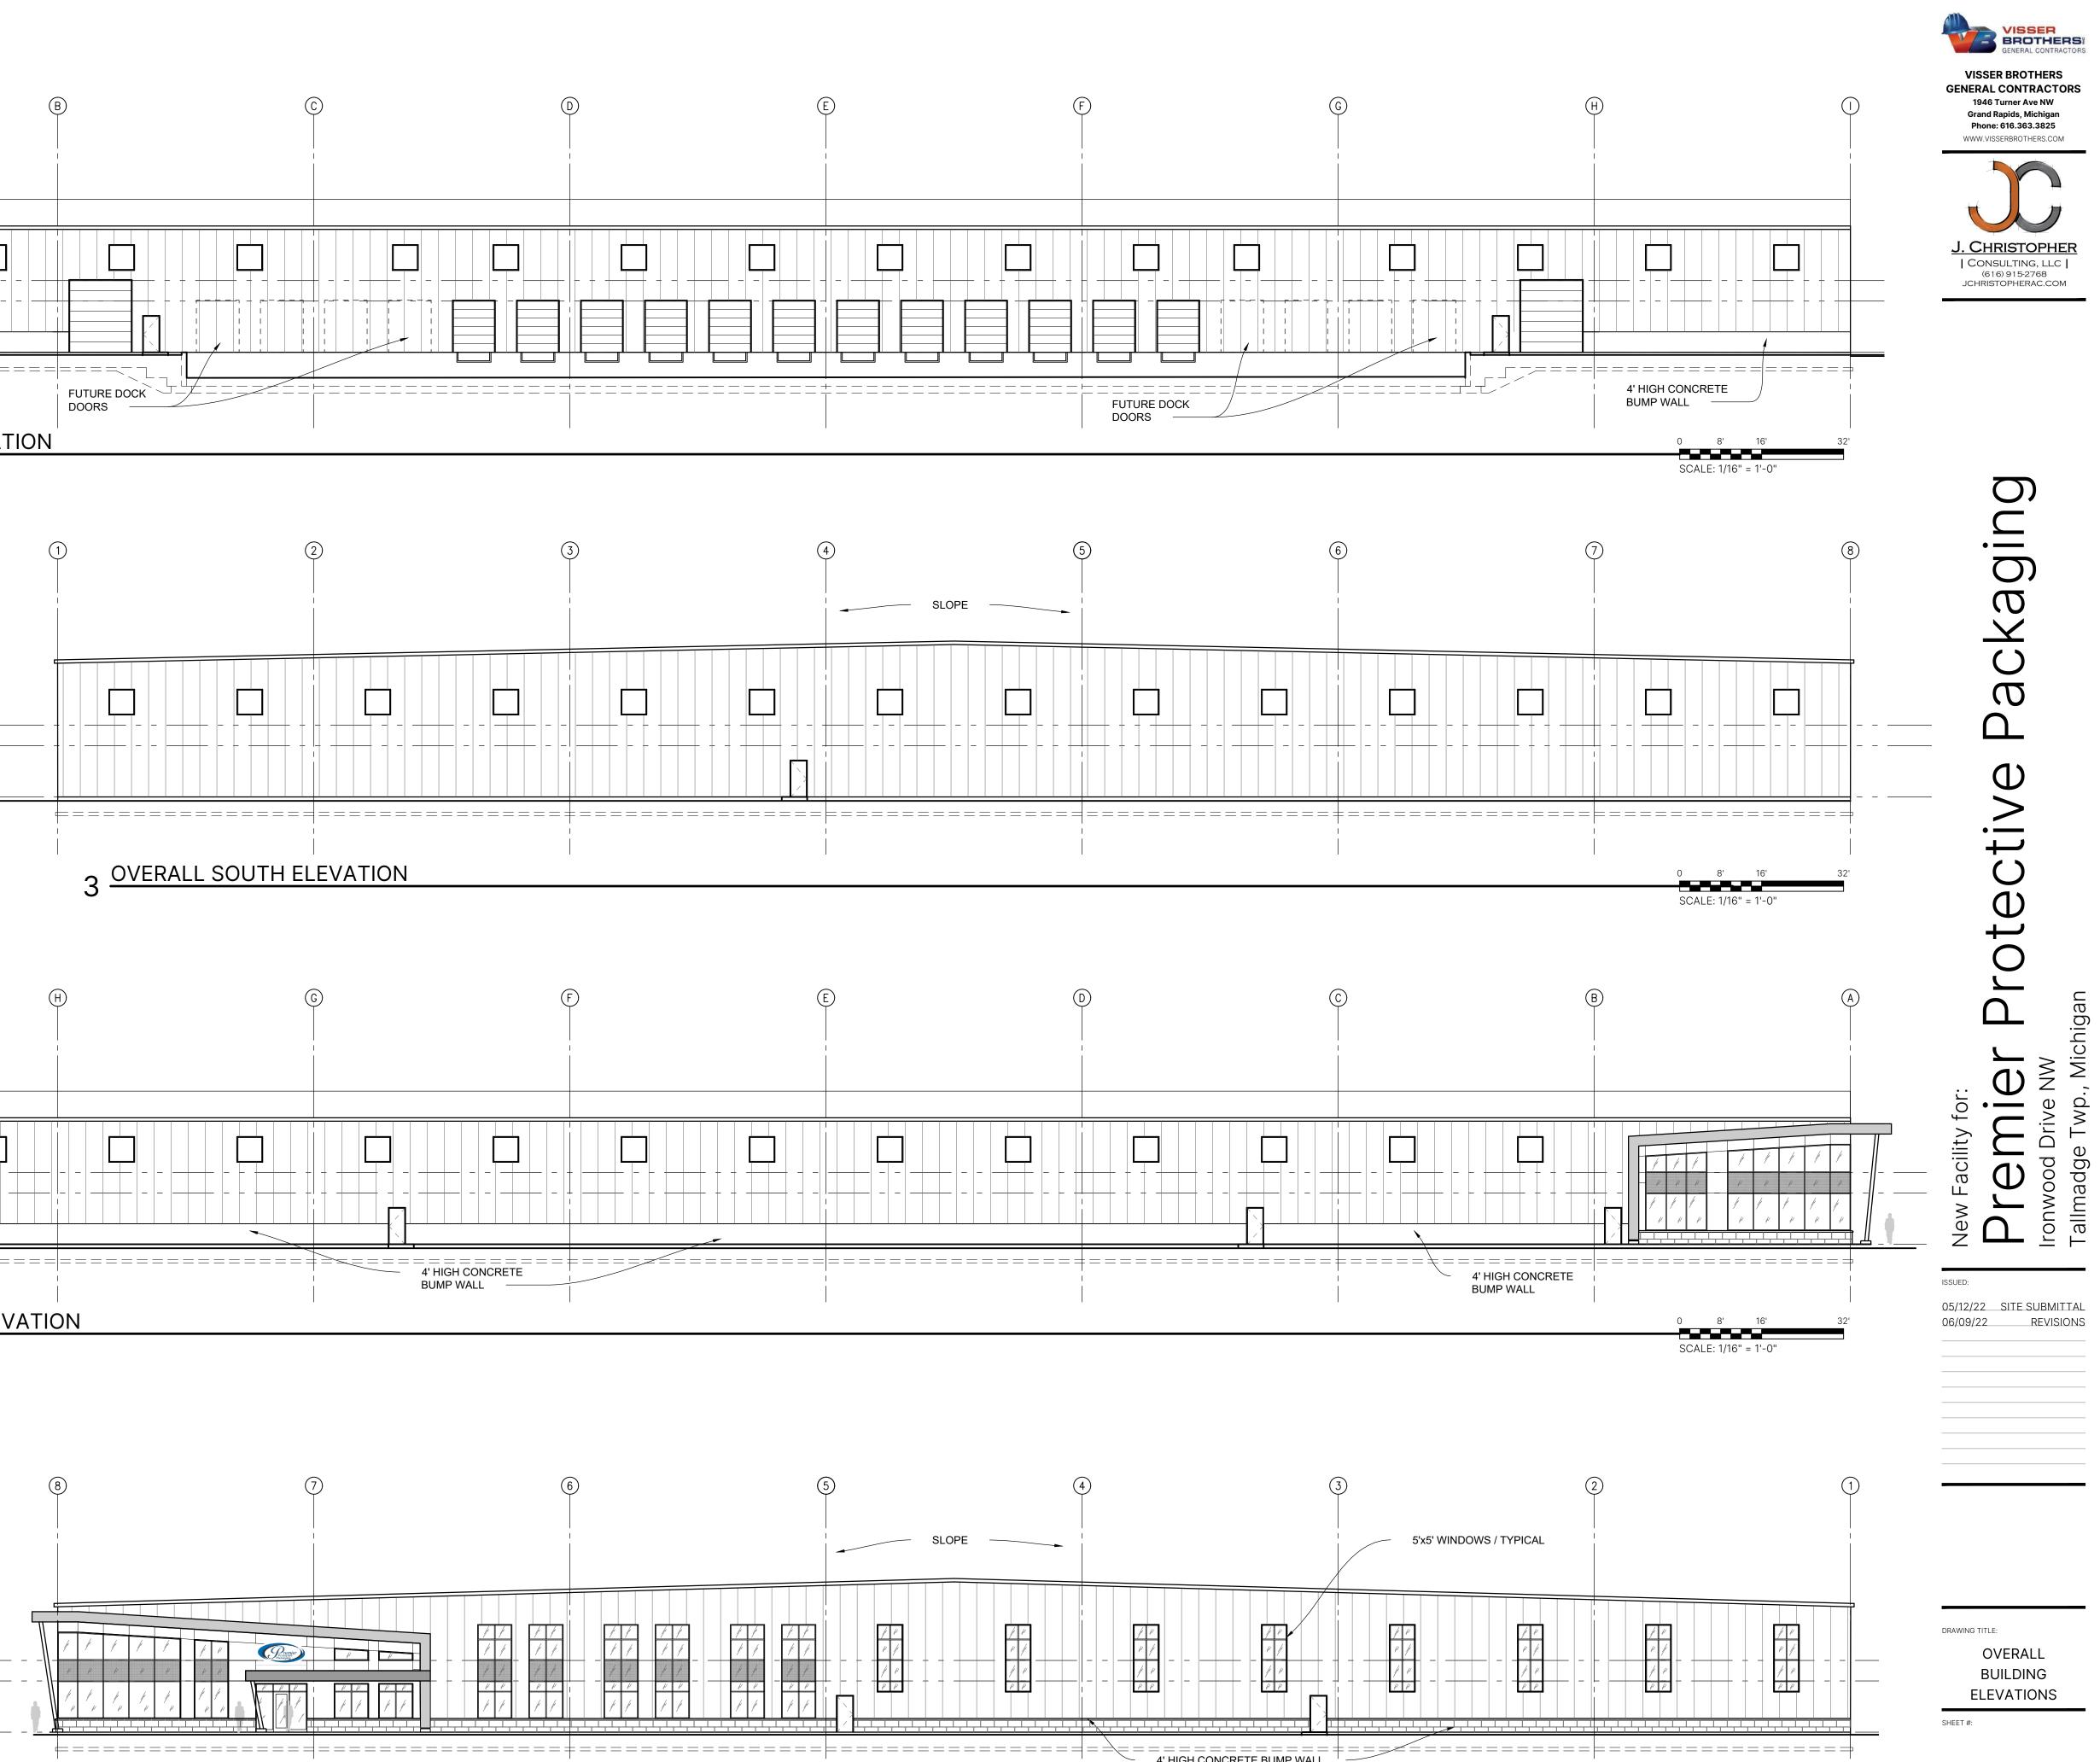

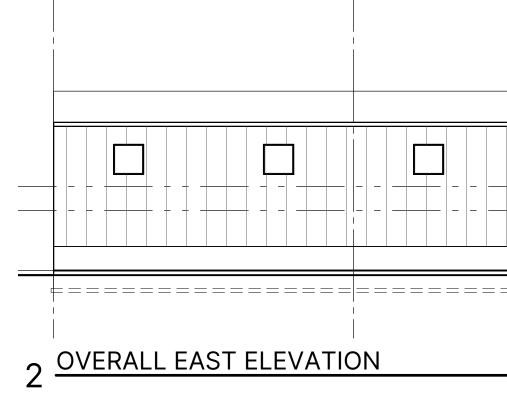

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